

Standard Bidding Document

SHIFTING OF GUY WIRE FOUNDATIONS OF MICROWAVE TOWER
AT 220KV GRID STATION SANGJANI DUE TO PASSAGE OF
MARGALLA LINK ROAD FROM G.T ROAD (N-5) TO MOTORWAY
M-1,(XEN-CIVIL-NGC-ISB-06/2025-26)
(Works)

National

Single Stage-Two Envelope



March 07, 2026

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REQUEST FOR BIDS
PROCUREMENT OF CIVIL WORKS

1. The **Assets Management (North), NGC Islamabad (Chief Engineer Asset Management National Grid Company (NGC-Islamabad))** has reserved Funds for the procurement planned for FY **2025-26**. The **Assets Management (North), NGC Islamabad (Chief Engineer Asset Management National Grid Company (NGC-Islamabad))** intends to apply part of the proceeds of this Fund to cover eligible payments under the contract for the "**SHIFTING OF GUY WIRE FOUNDATIONS OF MICROWAVE TOWER AT 220KV GRID STATION SANGJANI DUE TO PASSAGE OF MARGALLA LINK ROAD FROM G.T ROAD (N-5) TO MOTORWAY M-1,(XEN-CIVIL-NGC-ISB-06/2025-26)**".

2. The **Assets Management (North), NGC Islamabad (Chief Engineer Asset Management National Grid Company (NGC-Islamabad))** invites sealed Bids from eligible Bidders for procurement of Works (**SHIFTING OF GUY WIRE FOUNDATIONS OF MICROWAVE TOWER AT 220KV GRID STATION SANGJANI DUE TO PASSAGE OF MARGALLA LINK ROAD FROM G.T ROAD (N-5) TO MOTORWAY M-1,(XEN-CIVIL-NGC-ISB-06/2025-26)**) described in the bidding documents on **EPADS v2.0**.

3. **Single Stage-Two Envelope** will be used by adopting **Least Cost Based Selection (LCBS)** Technique for the subject procurement, in line with the Public Procurement Rules, 2004 and any Regulations, Regulatory Guides, Procurement Guidelines or Instructions issued by the Authority from time to time.


4. All Bids must be accompanied by a Bid Security amounting described in Bid Security Section in Bidding Document in the form of **Call at Deposit**. Or all bids must be accompanied by bid securing declaration in the format specified in the Bidding documents

5. E-Bidding documents, containing detailed terms & conditions, specifications and requirements etc. are available on **e-Pak Acquisition and Disposal System (EPADS)** at <https://vendors.epads.gov.pk/> for all the interested bidders registered on **EPADS v2.0**. Bidders are required to get themselves registered on **EPADS v2.0** to participate in Bidding process.

6. The e-bids, prepared in accordance with the instructions in the e-Bidding documents, must be submitted through **EPADS v2.0** on or before **Tuesday, March 31, 2026 11:00 AM**. E-bids will be opened by using **EPADS v2.0** on the same day at **Tuesday, March 31, 2026 02:30 PM**. Manual submission of Bids shall not be entertained. Those vendor who have not yet registered on the new version of **EPADS v2.0**, may register themselves on <https://pa.epads.gov.pk/>. A tutorial to explain the registration process is available at <https://www.youtube.com/watch?v=MNW6T38v7tc>.

In terms of Rules 48 of Public Procurement Rules, 2004 Grievance Redressal Committee (GRC) is notified for the subject procurement and notification copy is available on the procuring agency's website and on Authority's website at (www.ppra.org.pk).

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Instructions to Bidders

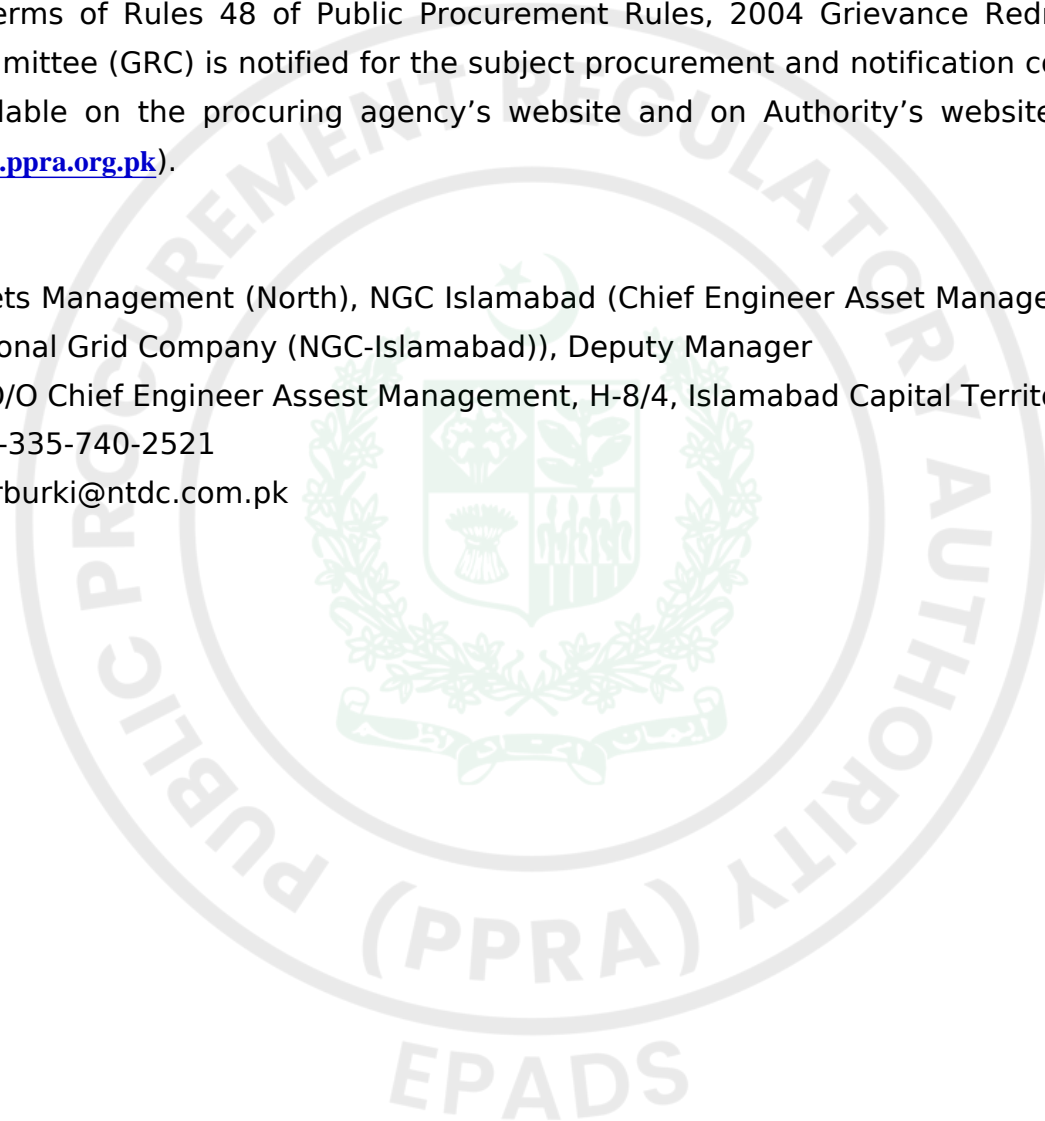A. INTRODUCTION

1. Scope of Bid

1.1. The Procuring agency/Employer (PA), as indicated in the Bid Data Sheet (BDS) invites Bids for the execution of Works as specified in the BDS and Section V- Works Requirements. The name, identification, and number of lots (contracts) of this National/ International Competitive Bidding process are specified in the BDS.

2. Source of Funds

2.1. Source of funds as referred in Clause 2 of Bid Data Sheet.

3. Eligible Bidders

3.1. A bidder may be natural person, company or firm or public or semi-public agency of Pakistan or any foreign country, or any combination of them with a formal existing agreement (on Judicial Papers) in the form of a joint venture or consortium. In the case of a joint venture or consortium, all members shall be jointly and severally liable for the execution of the Contract in accordance with the terms and conditions of the Contract. The joint venture or consortium shall nominate a Lead Member as nominated in the BDS, who shall have the authority to conduct all business for and on behalf of any and all the members of the joint venture or consortium during the Bidding process, and in case of award of contract, during the execution of contract. Verifiable copy of the agreement that forms a joint venture, consortium or association shall be required to be submitted as part of the Bid.

Any bid submitted by the joint venture, consortium or association shall indicate the part of proposed contract to be performed by each party and each party shall be evaluated (or post qualified if required) with respect to its contribution only, and the responsibilities of each party shall not be substantially altered without prior written approval of the Procuring Agency and in line with any instructions issued by the Authority.

(The limit on the number of members of JV or Consortium may be prescribed

in BDS, in accordance with the guidelines issued by the PPRA).

3.2. The invitation for bids is open to all prospective bidders subject to any provisions of incorporation or licensing by the respective national/international incorporating agency or statutory body established for that particular trade or business. Procuring agencies shall specify the registration/licensing requirements for the foreign bidder keeping in view the requirement of that business.

3.3. A Bidder shall not have a conflict of interest. All Bidders found to have a conflict of interest shall be disqualified. A Bidders may be considered to have a conflict of interest with one or more parties in this Bidding process, if they:

3.3.1. are associated or have been associated in the past, directly or indirectly with a firm or any of its affiliates which have been engaged by the Procuring agency/Employer to provide consulting services for the preparation of design or technical specifications of the works that are the subject of the bid; or

3.3.2. have controlling shareholders in common; or

3.3.3. receive or have received any direct or indirect subsidy from any of them; or

3.3.4. have the same legal representative for purposes of this Bid; or

3.3.5. have a relationship with each other, directly or through common third parties, that puts them in a position to have access to information about or influence on the bid of another bidder, or influence the decisions of the Procuring agency/Employer regarding this Bidding process; or

3.3.6. Submit more than one bid in this bidding process.

3.4. A Bidder may be ineligible if -

3.4.1. he is declared bankrupt or, in the case of company or firm, insolvent;

3.4.2. payments in favor of the bidder is suspended in accordance with the judgment of a court of law other than a judgment declaring bankruptcy and resulting (in accordance with the national laws) in the total or partial loss of the right to administer and dispose of its property;

3.4.3. the bidder is convicted, by a final judgment of a Court of Law or relevant Professional Statuary Body, of any offence involving professional conduct;

3.4.4. The bidder is debarred/ blacklisted by a national level Procuring agency/Employer and hence debarred due to involvement in corrupt and fraudulent practices, or performance failure or due to breach of bid securing declaration.

3.5. As and when required, bidders shall provide to the Procuring agency/Employer evidence of their eligibility, proof of compliance with the necessary legal requirements to carry out the contract effectively.

3.6. Bidders shall submit proposal relating to the nature, conditions and modalities of sub-contracting wherever the sub-contracting of any elements of the contract is envisaged.

4. Eligible Material and Equipment

4.1. All the material and equipment to be mobilized under the contract shall have their origin in eligible source countries, and all expenditures made under the contract will be limited to such materials and equipment. For this purpose, ineligible countries are stated in the section-IV titled as "Eligible Countries".

B. BIDDING DOCUMENTS

1. Contents of Bidding Documents

1.1. The scope of Works, bidding procedures, and terms and conditions of the contract are prescribed in the bidding documents. In addition to the Invitation for Bids, the bidding documents which should be read in

conjunction with any addenda issued in accordance with ITB 7.1 include:

- Section I -Invitation for Bids
- Section II Instructions to Bidders (ITBs)
- Section III Bid Data Sheet (BDS)
- Section IV Eligible Countries
- Section V Evaluation and Qualification Criteria
- Section VI Works Requirements Technical Specifications & Schedule of Requirements
- Section VII Standard Bidding Forms
- Section VIII General Conditions of Contract (GCC)
- Section IX Particular Conditions of Contract (PCC)
- Section X Contract Forms

1.2. The bidder is expected to examine all instructions, forms, specifications, terms and conditions prescribed in the bidding documents. Failure to furnish all the information required in the bidding documents will be at the bidder's risk and may result in the rejection of his bid.

2. Clarification of Bidding Document, Pre-bid Meeting

2.1. A prospective bidder requiring any clarification of the bidding document may notify the Procuring agency/Employer through EPADS.

2.2. The Procuring agency/Employer shall respond to the request for clarification in accordance with the Public Procurement Rules 2025, Rule No.38 i.e. Clarifications.

2.3. Should the Procuring Agency deem it necessary to amend the BIDDING document as a result of a clarification, it shall do so following the procedure under ITB 7.

2.4. If indicated in the BDS, the bidder's designated representative is invited at the bidder's cost to attend a pre-bid meeting at the place, date and time mentioned in the BDS. During this pre-bid meeting, prospective bidders may request clarification of the schedule of requirement, the evaluation criteria or any other aspects of the bidding documents.

2.5. Minutes of the pre-bid meeting, if applicable, including the text of the questions asked by bidders, including those during the meeting (without identifying the source) and the responses given, together with any responses prepared after the meeting will be uploaded on EPADS. Any modification to the bidding documents that may become necessary as a result of the pre-bid meeting shall be made by the Procuring agency/Employer exclusively through the use of an Addendum pursuant to ITB 7. Non-attendance at the pre-bid meeting will not be a cause for disqualification of a bidder.

2.6. The bidder is advised to visit and examine the Site of Works and its surroundings and obtain for itself on its own responsibility all information that may be necessary for preparing the bid and entering into a contract for construction of the Works. The costs of visiting the Site shall be at the bidder's own expense.

2.7. The bidder and any of its authorized personnel will be granted permission by the Procuring agency/Employer to enter upon its premises and lands for the purpose of such visit, but only upon the express condition that the bidder and its personnel will release and indemnify the Procuring agency/Employer from and against all liability in respect thereof, and will be responsible for death or personal injury, loss of or damage to property, and any other loss, damage, costs, and expenses incurred as a result of the inspection.

3. Amendment of Bidding Documents

3.1. The procuring agency may issue notification of any change, addition, modification or deletion in accordance with the PP Rules 2025, rule no. 34 i.e. Bidding Documents.

3.2. To give prospective bidders reasonable time in which to take an addendum/corrigendum into account in preparing their bids, the Procuring agency/Employer may, at its discretion, extend the deadline for the submission of bids:

Provided that the Procuring agency/Employer shall extend the deadline for submission of bid in pursuance of PP Rules 2025, rule no. 39 i.e. Extension of time for submission of bids, if such an addendum is issued within last

three (03) days of the bid submission deadline.

C. PREPARATION OF BIDS

1. Language of Bid

1.1. The bid prepared by the bidder, as well as all correspondence and documents relating to the bid exchanged by the bidder and the Procuring agency/Employer shall be written in the English language unless specified in the BDS. Supporting documents and printed literature furnished by the bidder may be in another language provided they are accompanied by an accurate translation of the relevant pages in the English language unless specified in the BDS, in which case, for purposes of interpretation of the bidder, the translation shall govern.

2. Documents Constituting the Bids

2.1. The Bids prepared by the Bidder shall constitute of all the documents required in the BDS.

3. Documents Establishing Eligibility of Material, Equipment and Works, their Conformity to Bidding Documents

3.1. The bid prepared by the bidder shall constitute the following components: -

3.1.1. Documentary evidence established in accordance with ITB 10 that the material and equipment to be utilized by the Bidder for the executions of works are eligible material and equipment and conform to the Bidding Documents;

3.1.2. Documentary evidence established in accordance with ITB 11 that the bidder has been authorized to carry out the Construction works;

3.1.3. Documentary evidence established in accordance with ITB 11 that the bidder is eligible and/or qualified for the subject bidding process;

3.1.4. Form of Bid and Bid Prices completed in accordance with ITB 12 and 13;

3.1.5. Completed schedules as required, including priced Bill of Quantities in accordance with ITB 13.

3.1.6. Technical Proposal completed in all aspects in accordance with ITB-15.

3.1.7. Bid security or Bid Securing Declaration furnished in accordance with ITB 17;

3.1.8. Any other document required in the BDS.

3.2. In addition to the requirements, bids submitted by a JV shall include a copy of the Joint Venture Agreement entered into by all members. Alternatively, a letter of intent to execute a Joint Venture Agreement in the event of a successful bid shall be signed by all members and submitted with the bid, together with a copy of the proposed Agreement.

3.3. The bidder shall furnish, as part of its bid, all those documents establishing the eligibility in conformity to the terms and conditions specified in the bidding documents for all material, equipment and works which the bidder proposes to execute.

3.4. The documentary evidence of conformity of the material, equipment and works to the Bidding Documents may be in the form of literature, drawings, and data, and shall consist of:

3.4.1. a detailed description of the work methodology, approach, schedule and resources to be mobilized at site;

3.4.2. an item-by-item commentary on the Procuring agency/Employer's Technical Specifications demonstrating substantial responsiveness of the material, equipment and works to those specifications, or a statement of deviations and exceptions to the provisions of the Technical Specifications;

3.4.3. any other procurement specific documentation requirement as stated in the BDS.

3.5. The required documents and other accompanying documents must be in English. In case any other language than English is used the pertinent translation into English shall be attached to the original version.

4. Documents Establishing Eligibility and Qualification of the Bidder

4.1. The bidder shall furnish, as part of its bid, all those documents establishing the bidder's eligibility to participate in the bidding process and/or its qualification to perform the contract if its bid is accepted.

4.2. The documentary evidence of the bidder's eligibility to bid shall establish to the satisfaction of the Procuring agency/Employer that the bidder, at the time of submission of its bid, is from an eligible country as defined in Section-IV titled as "Eligible Countries".

4.3. The documentary evidence of the bidder's qualification to perform the contract if its bid is accepted shall establish to the satisfaction of Procuring agency/Employer that:

4.3.1. The bidder has the financial and technical capability necessary to perform the Contract, meets the qualification criteria specified in Section-V, Evaluation and Qualification Criteria and BDS.

4.3.2. In the case of a bidder not doing business within Pakistan, the bidder is or will be (if awarded the contract) represented by a local bidder (Joint Venture) in accordance with the PEC works bylaws, and in case of award of works such foreign firm is required to participate in the execution of works to carry out its obligations as prescribed in the Conditions of Contract and /or Technical Specifications.

4.3.3. That the bidder meets the qualification criteria listed in Section-V, Evaluation and Qualification Criteria and BDS.

5. Forms of Bid

5.1. The Bidder shall fill the Form of Bids furnished in the bidding documents. The Bids Form must be completed without any alterations to its format and no substitute shall be accepted.

6. Bid Prices

6.1. The bid prices quoted by the bidder in the Standard bid Forms, Bill of Quantities and in the Price Schedules shall conform to the requirements specified below or exclusively mentioned hereafter in the bidding documents.

6.2. The bidder shall fill in rates and prices for all items of the Works described in the Bill of Quantities. If a Price Schedule shows items listed but not priced, their prices shall be construed to be included in the prices of other items in the Bill of Quantities and will not be paid for separately by the Procuring agency/Employer.

6.3. Items not listed in the Price Schedule shall be assumed not to be included in the bid, and provided that the bid is still substantially responsive in their absence or due to their nominal nature, the corresponding average price of the respective item(s) of the remaining substantially responsive bidder(s) shall be construed to be the price of those missing item(s):

Provided that:

6.3.1. where there is only one (substantially) responsive bidder, or

6.3.2. where there is provision for alternate proposals and the respective items are not listed in the other bids,

The Procuring agency/Employer may fix the price of missing items in accordance with market survey, and the same shall be considered as final price.

6.4. The Bid price to be quoted in the Form of Bid in accordance with ITB 12 shall be the total price of the bid.

6.5. Unless otherwise specified in the BDS and the Contract, the rates and prices quoted by the bidder are subject to adjustment during the performance of the Contract in accordance with the provisions of the

Conditions of Contract.

6.6. If so specified in ITB 1.1, bids may be invited for individual lots (contracts) or for any combination of lots (packages).

6.7. Prices quoted by the Bidder shall be fixed during the bidder's performance of the contract and not subject to variation on any account. A bid submitted with an adjustable price will be treated as non-responsive and shall be rejected, pursuant to ITB 27, unless otherwise price adjustment is permissible under Conditions of the Contract.

6.8. All duties, taxes, and other levies payable by the Contractor under the Contract, or for any other cause, as of the date twenty-eight (28) days prior to the deadline for submission of bids, shall be included in the rates and prices and the total bid price submitted by the bidder.

7. Currencies of Bid and Payment

7.1. Prices shall be quoted in Pakistani Rupees unless otherwise specified in the BDS. Comparison of bids and tie of bid shall be treated in accordance with the PP rules 2025, rule no. 42.

8. Documents Comprising the Technical Proposal

8.1. The bidder shall furnish a Technical Proposal including a statement of work methods, equipment, personnel, schedule and any other information as stipulated in Section VII - Standard Bid Forms, in sufficient detail to demonstrate the adequacy of the bidder's proposal to meet the work requirements and the completion time.

9. Bid Validity Period

9.1. Bids shall remain valid for the period specified in the BDS after the bid submission deadline prescribed by the Procuring agency/Employer. A bid valid for a shorter period shall be rejected by the Procuring agency/Employer as non-responsive. The period of bid validity will be determined from the complementary bid securing instrument i.e. the expiry period of bid security or bid securing declaration as the case may be.

9.2. Under exceptional circumstances, prior to the expiration of the initial Bids/Bid validity period, the Procuring Agency may request the Bidders' consent to an extension of the period of validity of their Bids/Bid. Such request for extension of the period of bid validity shall be carried out in accordance with the PP rules 2025, rule no. 37 i.e. Bid Validity.

10. Bid Security or Bid Securing Declaration

10.1. Pursuant to ITB 11.1 unless otherwise specified in the BDS, the bidder shall furnish as part of its bid, a Bid Security in accordance with the PP Rules 2025, rule no. 36 in the amount and currency specified in the BDS or Bid Securing Declaration as specified in the BDS in the format provided in Section VII (Standard Bidding Forms).

In case Procuring agency/Employer is inviting bids in lots / packages, the bidder shall be required to submit his bid security against the respective lot/package for which he is submitting his bid.

Until the development of functionality of auto verification of financial instrument in EPADS, the scanned copy of bid security or bid securing declaration, as the case may be, shall be uploaded on E-PADS whereas the original instrument to be submitted to the procuring agency before closing of bid submission deadline,

10.2. The Bid Security shall be denominated in the local currency or in another freely convertible currency, and it shall be in the form specified in the **BDS** which shall be in any of the following:

10.2.1. A bank guarantee, an irrevocable letter of credit issued by a Scheduled bank in the form provided in the Bidding Documents or another form acceptable to the Procuring agency/Employer and valid for twenty-eight (28) days beyond the end of the validity of the Bid. This shall also apply if the period for Bid Validity is extended. In either case, the form must include the complete name of the bidder;

10.2.2. A cashier's or certified cheque; or

10.2.3. Another security as indicated in the **BDS**.

10.3. The Bid Security or Bid Securing Declaration shall be in accordance with the Form of the Bid Security or Bid Securing Declaration included in Section VII (Standard Bidding Forms) or another form approved by the Procuring agency/Employer prior to the bid submission.

10.4. The Bid Security shall be payable promptly upon written demand by the Procuring agency/Employer in case any of the conditions listed in ITB 17.9 are invoked.

10.5. Any bid not accompanied by a Bid Security or Bid Securing Declaration in accordance with ITB 17.1 or 17.3 shall be rejected by the Procuring agency/Employer and shall be declared as non-responsive bid, pursuant to ITB 27.

10.6. Unsuccessful bidders' Bid Security will be discharged or returned as promptly as possible, however in no case later than thirty (30) days after the expiration of the period of Bid Validity prescribed by the Procuring agency/Employer pursuant to ITB 16. The Procuring agency/Employer shall make no claim to the amount of the Bid Security, and shall promptly return the Bid Security document, after whichever of the following that occurs earliest:

10.6.1. The expiry of the Bid Security;

10.6.2. The entry into force of a procurement contract and the provision of a performance security (or guarantee), for the performance of the contract if such a security (or guarantee), is required by the Bidding documents;

10.6.3. The rejection by the Procuring agency/Employer of all Bids;

10.6.4. The withdrawal of the bid prior to the deadline for the submission of bids, unless the bidding documents stipulate that no such withdrawal is permitted.

10.7. The successful bidder's Bid Security will be discharged upon the bidder signing the contract pursuant to ITB 40, or furnishing the performance security (or guarantee), pursuant to ITB 41.

10.8. The Bid Security may be forfeited or the Bid Securing Declaration executed:

10.8.1. if a Bidder:

10.8.1.1. Withdraws its Bid during the period of Bid Validity as specified by the Procuring agency/Employer, and referred by the bidder on the Form of Bid except as provided for in ITB 16.2; or

10.8.2. In the case of a successful bidder, if the bidder fails:

10.8.2.1. to sign the contract in accordance with ITB 40; or

10.8.2.2. to furnish performance security (or guarantee) in accordance with ITB 41.

10.9. In case of Bid Security issued by the foreign bank is allowed by the Procuring agency/Employer, the same should be counter guaranteed by a corresponding bank in Pakistan. Furthermore, in case of joint venture, it should be in the name of Joint venture to ensure joint responsibility. In case the JV is not legally constituted at the time of bid submission, the bid security or bid securing declaration shall be in the names of all future members as named in the letter of bid.

11. Withdrawal of Bids

11.1. Before bid submission deadline, any bidder may withdraw, substitute, or modify its bid after it has been submitted by sending a written notice, duly signed by an authorized representative, and the corresponding must accompany the respective written notice.

12. Format and Signing of Bid

12.1. The Bidder shall prepare and submit Bids through EPADS with due diligence after carefully reading all the terms and condition before bid submission deadline.

D. SUBMISSION OF BIDS

1. **Submission of Bids through EPADS v2.0**

1.1. All bids shall be submitted through EPADS v2.0.

2. **Deadline for Submission of Bids**

2.1. All bids shall be received through **EPADS v2.0** not later than bid submission deadline as specified in the **BDS**.

2.2. The Procuring agency/Employer may, under exceptional circumstances and at its discretion, extend the deadline for the submission of bids, pursuant to PP Rules 2025, rule no.39 Extension of Time for submission of bid, by amending the Bidding Documents in accordance with ITB 7, in which case all rights and obligations of the Procuring agency/Employer and bidders previously subject to the deadline will thereafter be subject to the new deadline.

3. **Substitution and Modification of bids**

3.1. A bidder may substitute or modify his bid after it has been submitted, provided that written notice of the substitution or modification of the bid, is received by the Procuring agency/Employer prior to the deadline for submission of bids.

3.2. Revised bid may be submitted after the substitution or modification made in the original bid in accordance with the provisions referred in **ITB 18**.

E. **OPENING AND EVALUATION OF BIDS**

1. **Opening of Bids**

1.1. The Procuring Agency will open bids in accordance with the PP rules 2025, rule no 40 and as specified in the BDS.

2. **Confidentiality**

2.1. Information relating to the examination, clarification, evaluation and comparison of bids and recommendation of contract award shall not be disclosed to bidders or any other persons not officially concerned with such process until the time of the announcement of the respective evaluation report.

3. Clarification of Bids

3.1. Clarification of Bidding Documents shall be carried out in accordance with the **PP Rules 2025**, rule no 38 i.e. Clarifications.

3.2. The alteration or modification in the bid which in any case affect the following parameters will be considered as a change in the substance of a bid:

- 3.2.1. evaluation & qualification criteria;
- 3.2.2. required scope of work;
- 3.2.3. contract price;
- 3.2.4. all securities requirements;
- 3.2.5. tax requirements;
- 3.2.6. terms and conditions of bidding documents.
- 3.2.7. change in the ranking of the bidder

4. Preliminary Examination of Bids

4.1. Prior to the detailed evaluation of bids, the Procuring agency/Employer will determine whether each bid:

- 4.1.1. meets the eligibility criteria defined in **ITB 3** and **ITB 4**;
- 4.1.2. has been prepared as per the format and contents defined by the Procuring agency/Employer in the bidding documents;
- 4.1.3. has been properly signed;

4.1.4. is accompanied by the required securities; and

4.1.5. is substantially responsive to the requirements of the bidding documents.

The Procuring agency/Employer's determination of a bid's substantial responsiveness will be based on the contents of the bid itself.

4.2. A substantially responsive Bid is one which conforms to all the terms, conditions, and specifications of the Bidding Documents, without material deviation or reservation. A material deviation or reservation is one that: -

4.2.1. affects in any substantial way the scope, quality, or performance of the Works;

4.2.2. limits in any substantial way, inconsistent with the bidding documents, the Procuring agency/Employer's rights or the bidders' obligations under the Contract; or

4.2.3. if rectified, would affect unfairly the competitive position of other bidders presenting substantially responsive bids.

4.3. The Procuring agency/Employer will confirm that the documents and information specified under ITB 9, 10 and 11 have been provided in the bid. If any of these documents or information is missing, or is not provided in accordance with the Instructions to Bidders, the bid shall be rejected.

4.4. The Procuring agency/Employer may waive-off any minor informality, nonconformity, or irregularity in a bid which does not constitute a material deviation, provided such waiver does not prejudice or affect the relative ranking of any Bidder.

Explanation: A minor informality, non-conformity or irregularity is one that is merely a matter of form and not of substance. It also pertains to some immaterial defect in a Bid or variation of a bid from the exact requirements of the invitation that can be corrected or waived without being prejudicial to other bidders. The defect or variation is immaterial when the effect on quantity, quality, or delivery is negligible when contrasted with the total cost or scope of the works. The Procuring agency/Employer either shall give the bidder an opportunity to cure any deficiency resulting from a minor

informality or irregularity in a bid or waive the deficiency, whichever is advantageous to the Procuring agency/Employer. Examples of minor informalities or irregularities include failure of a bidder to –

4.4.1. Submit the number of copies of signed bids required by the invitation;

4.4.2. Furnish required information concerning the number of its employees;

4.4.3. the firm submitting a bid has formally adopted or authorized, before the date set for opening of bids, the execution of documents by typewritten, printed, or stamped signature and submits evidence of such authorization and the bid carries such a signature.

4.5. Provided that a Technical Bid is substantially responsive, the Procuring agency/Employer may request the bidder to submit the necessary information or documentation, within a reasonable period of time, to rectify nonmaterial nonconformities or omissions in the Technical Bid related to documentation requirements. Requesting information or documentation on such nonconformities shall not be related to any such aspect of the technical Proposal linked with the ranking of the bidders. Failure of the bidder to comply with the request may result in the rejection of its bid.

4.6. Provided that a Technical Bid is substantially responsive, the Procuring agency/Employer shall rectify quantifiable nonmaterial nonconformities or omissions related to the Financial Proposal. To this effect, the Bid Price shall be adjusted, for comparison purposes only, to reflect the price of the missing or nonconforming item or component.

4.7. If a bid is not substantially responsive, it will be rejected by the Procuring agency/Employer and may not subsequently be evaluated for complete technical responsiveness.

5. Examination of Terms and Conditions; Technical Evaluation

5.1. The Procuring agency/Employer shall examine the bid to confirm that all terms and conditions specified in the **GCC** and the **PCC** have been accepted

by the bidder without any material deviation or reservation.

For this purpose:

“Deviation” means departure from the requirements specified in the Bidding Document.

“Reservation” means setting of limiting conditions or withholding from complete acceptance of the requirements specified in the Bidding Document.

5.2. The Procuring agency/Employer shall evaluate the technical aspects of the bid submitted in accordance with ITB 30, to confirm that all requirements specified in Section VI – Works Requirement, Technical Specifications of the Bidding Documents have been met without material deviation or reservation.

5.3. If after the examination of the terms and conditions and the technical evaluation, the Procuring agency/Employer determines that the bid is not substantially responsive in accordance with ITB 27, it shall reject the bid.

6. Correction of Arithmetic Errors

6.1. Bids determined to be substantially responsive will be checked for any arithmetic errors. Errors will be corrected as follows: -

6.1.1. if there is a discrepancy between unit prices and the sub-total price that is obtained by multiplying the unit price and quantity, the unit price shall prevail, and the sub-total price shall be corrected, unless in the opinion of the Procuring agency/Employer there is an obvious misplacement of the decimal point in the unit price, in which the total price as quoted shall govern and the unit price shall be corrected;

6.1.2. if there is an error in a total corresponding to the addition or subtraction of sub-totals, the sub-totals shall prevail, and the total shall be corrected; and

6.1.3. where there is a discrepancy between the amounts in figures and in words, the amount in words will govern.

6.1.4. Where there is discrepancy between grand total of price schedule and amount mentioned on the Form of Bid, the amount referred in Price Schedule shall be treated as correct subject to elimination of other errors.

6.2. The amount stated in the Bid will, be rectified by the Procuring agency/Employer in accordance with the above procedure for the correction of errors and, with, the concurrence of the bidder, shall be considered as binding upon the bidder. If the bidder does not accept the corrected amount, its bid shall be rejected after forfeiture of Bid Security or execution of the Bid Securing Declaration, as the case may be, in accordance with **ITB 41.3**.

7. Conversion to Single Currency

7.1. The unit rates and the prices shall be quoted by the bidder entirely in Pak rupees. A bidder expecting to incur expenditures in other currencies for inputs to the Works from outside the Procuring agency/Employer's country (referred to as the "Foreign Currency Requirements") shall indicate the same in the letter of bid-financial proposal. The proportion of the Bid Price (excluding Provisional Sums) needed by him for the payment of such Foreign Currency Requirements either (i) entirely in the currency of the Bidder's home country or, (ii) at the bidder's option, entirely in Pak rupees provided always that a bidder expecting to incur expenditures in a currency or currencies other than those stated in (i) and (ii) above for a portion of the foreign currency requirements, and wishing to be paid accordingly, shall indicate the respective portions in his bid. Comparison of bids quoted in different currencies and conversion of bids into a single currency shall be carried out in accordance with the **PP Rule 2025, rule no. 42 (2)**.

8. Evaluation of Bids

8.1. The Procuring agency/Employer shall evaluate and compare only the bids determined to be substantially responsive, pursuant to **ITB 27**.

8.2. In evaluating the Technical Proposal of each Bid, the Procuring agency/Employer shall use the criteria and methodologies listed in the BDS and in terms of works requirement. No other evaluation criteria or

methodologies shall be permitted.

8.3. The Procuring agency/Employer's evaluation of a bid will take into account:

8.3.1. the bid price, excluding provisional sums and the provision, if any, for contingencies in the summary bill of quantities, but including day work items, where priced competitively;

8.3.2. converting the amount resulting from applying above, if relevant, to a single currency in accordance with ITB 29;

8.4. The estimated effect of the price adjustment provisions of the Conditions of Contract, applied over the period of execution of the Contract, shall not be taken into account in bid evaluation.

8.5. If these bidding documents allow bidders to quote separate prices for different lots, and the award to a single bidder of multiple lots, the methodology of evaluation to determine the lowest evaluated lot combinations in the Form of Bid, is specified in the **BDS**.

8.6. If the bid, which results in the Evaluated Bid Price (Successful Bid), is seriously unbalanced or front loaded in the opinion of the Employer, the Employer may require the Bidder to produce detailed price analyses for any or all items of the Bill of Quantities, to demonstrate the internal consistency of those prices with the construction methods and schedule proposed. After evaluation of the price analyses, taking into consideration the schedule of estimated Contract payments, the Employer may require that the amount of the performance security be increased at the expense of the Bidder to a level sufficient to protect the Employer against financial loss in the event of default of the successful Bidder under the Contract.

Explanation:

"Unbalanced" or "front-loaded" bids consist of deliberately submitting bids with artificially high prices or unit rates for the early stages of a construction project, offset by artificially low prices or unit rates for the later stages of the project, to improve the contractor's cash flow.

9. Domestic Preference

9.1. If the **BDS** so specifies, the Procuring agency/Employer will grant a margin of preference to the domestic contractor in line with the rules, regulations, regulatory guides or instructions issued by the Authority from time to time.

10. Determination of Successful Bid

10.1. The Procuring agency/Employer shall compare the evaluated bids in accordance with the predefined bidding procedure, of all substantially responsive bids to determine the Successful bidder.

11. Qualification of Bidder

11.1. The Procuring agency/Employer shall determine to its satisfaction whether the bidder is substantially responsive and whose bid is declared as Successful bid either continues to meet (if prequalification applies) or meets (if post-qualification applies) the qualifying criteria specified in Evaluation and Qualification Criteria.

Note: In case of international bidding, the parameters for incorporation or licensing within Pakistan may be fulfilled as part of post qualification.

11.2. The determination shall be based upon an examination of the documentary evidence of the bidder's qualifications submitted by the bidder, pursuant to **ITB 11**.

11.3. Prior to contract award, the Procuring agency/Employer will verify that the successful bidder (including each member of a JV) is not blacklisted/debarred. The Procuring agency/Employer will conduct the same verification for each sub-contractor proposed by the successful bidder.

12. Sub-Contractors

12.1. The bidder shall provide details regarding any specialized sub-contractor to the Procuring agency/Employer. In case change of sub-contractors, the bidder shall promptly notify the Procuring agency/Employer and obtain approval for replacement of sub-contractors.

12.2. Bidders may propose sub-contracting up to the percentage of total value of contracts or the volume of works as specified in the **BDS**.

13. **Abnormally Low Financial Bid**

13.1. A procuring Agency may reject abnormally low bids in accordance with the PP Rules 2025 rule no. 43. The decision of the Procuring agency/Employer to reject a bid and reasons for the decision shall be recorded in the procurement proceedings and promptly communicated to the bidder concerned. Moreover, the Procuring agency/Employer shall not incur any liability solely by rejecting abnormally bid

Guidance for Procuring agency/Employer:

An abnormally low bid means, in the light of the Procuring agency/Employer's estimate and of all the bids submitted, the bid appears to be abnormally low by not providing a margin for normal levels of profit. In order to identify the Abnormally Low Bid (ALB) following approaches can be considered to minimize the scope of subjectivity:

13.1.1. Comparing the bid price with the cost estimate;

13.1.2. Comparing the bid price with the bids offered by other bidders submitting substantially responsive bids; and

13.1.3. Comparing the bid price with prices paid in similar contracts in the recent past either government- or development partner-funded.

13.2. The Procuring agency/Employer will determine to its satisfaction whether the bidder that is selected as having submitted the successful bid is qualified to perform the contract satisfactorily, in accordance with the criteria listed in **ITB 11**

13.3. The determination will take into account the bidder's financial and technical capabilities. It will be based upon an examination of the documentary evidence of the bidder's qualifications submitted by the bidder, pursuant to **ITB 11**, as well as such other information as the Procuring agency/Employer deems necessary and appropriate. Factors not included in these bidding documents shall not be used in the evaluation of the bidders' qualifications.

13.4. Procuring agency/Employer may seek “Certificate for Independent Price Determination” from the bidder and the results of reference checks may be used in determining award of contract.

Explanation: The Certificate shall be furnished by the bidder. The bidder shall certify that the price is determined keeping in view of all the essential aspects such as raw material, its processing, value addition, optimization of resources due to economy of scale, transportation, insurance and margin of profit etc.

13.5. An affirmative determination will be a prerequisite for award of the contract to the bidder. A negative determination will result in rejection of the bidder’s bid, in which event the Procuring agency/Employer will proceed to the next ranked bidder to make a similar determination of that bidder’s capabilities to perform satisfactorily.

F. AWARD OF CONTRACT

1. Criteria of Award

1.1. Subject to **ITB 36 and 37**, the Procuring agency/Employer will award the Contract to the bidder whose bid has been determined to be substantially responsive to the bidding documents and who has been declared as Successful Bidder, provided that such bidder has been determined to be:

1.1.1. eligible in accordance with the provisions of **ITB 3**;

1.1.2. is determined to be qualified to perform the Contract satisfactorily;
and

1.1.3. Successful negotiations have been concluded, if any.

2. Negotiations

2.1. The Committee of the Procuring agency/Employer may negotiate with the Most Advantageous Bidder relating to the following areas:

2.1.1. a minor alteration to the technical (drawings, design technical specifications) details of the statement of works;

2.1.2. Methodology, work plan, staffing in view to streamline the work;

2.1.3. a minor amendment to the Particular conditions of Contract;

2.1.4. finalizing payment arrangements;

2.1.5. clarifying details that were not apparent or could not be finalized at the time of Bidding;

2.2. Where negotiation fails to result into an agreement, the Procuring agency/Employer may invite the next ranked bidder for negotiations. Where negotiations are commenced with the next ranked bidder, the Procuring agency/Employer shall not reopen earlier negotiations.

3. Procuring agency/Employer's Right to reject All Bids

3.1. The procuring agency has the right to reject all bids in accordance with the **PP Rules 2025 rule no. 45**. However, the Authority (i.e. **PPRA**) may call from the Procuring agency/Employer the justification of those grounds.

4. Notification of Award

4.1. The procuring agency shall announce and publish the evaluation result in accordance with the **PP Rules 2025**, rule no. **48**.

4.2. Where no complaints have been lodged, the bidder whose bid has been accepted will be notified of the award by the Procuring agency/Employer prior to expiration of the bid validity period through EPADS. However, the Procuring agency/Employer shall not award any procurement contract at least for five (05) days after the announcement of final evaluation report. The notification letter (herein after and in the condition of the contract and contract form called "Letter of Acceptance" will specify the sum that the Procuring agency/Employer will pay the successful bidder in consideration for the execution and completion of the works as prescribed by the Contract (hereinafter and in the Contract called the "Contract Price).

4.3. The notification of award will constitute the formation of the Contract, subject to the bidder furnishing the Performance Security (or guarantee) in accordance with **ITB 41** and signing of the contract in accordance with **ITB 40**.

4.4. Upon the successful bidder's furnishing of the performance security (or guarantee) pursuant to **ITB 41**, the Procuring agency/Employer will promptly notify each unsuccessful bidder, the name of the successful bidder and the Contract amount and will discharge the Bid Security or Bid Securing Declaration of the bidder(s) pursuant to **ITB 17**.

5. **Signing of Contract**

5.1. Promptly after notification of award, Procuring agency/Employer shall send the successful bidder the draft agreement, incorporating all terms and conditions as agreed by the parties to the contract.

5.2. Immediately after the Redressal of grievance by the **GRC**, and after fulfillment of all conditions precedent of the Contract Form, the successful bidder and the Procuring agency/Employer shall sign the contract.

5.3. Where no formal signing of a contract is required, work order issued to the bidder shall be construed to be the contract.

6. **Performance Security (or Guarantee)**

6.1. After the receipt of the Letter of Acceptance, the successful bidder, within the specified time, shall deliver to the Procuring agency/Employer a Performance Guarantee in the amount and in the form stipulated in the BDS and PCC, denominated in the type and proportions of currencies in the Letter of Acceptance and in accordance with the Conditions of Contract.

6.2. If the Performance Guarantee is provided by the successful bidder and it shall be in the form specified in the BDS which shall be in any of the following:

6.2.1. certified cheque, cashier's or manager's cheque, or bank draft;

6.2.2. irrevocable letter of credit issued by a scheduled bank of Pakistan or in the case of an irrevocable letter of credit issued by a foreign bank, the letter shall be confirmed or authenticated by a scheduled bank of Pakistan;

6.2.3. bank guarantee confirmed by a reputable local bank or, in the case of a successful foreign bidder, bonded by a foreign bank; or

6.2.4. surety bond callable upon demand issued by any reputable surety or insurance company.

Any Performance Guarantee submitted shall be enforceable in Pakistan.

6.3. Failure of the Most Advantageous Bidder to comply with the requirement of **ITB 40** shall constitute sufficient grounds for the annulment of the award and forfeiture of the Bid Security or declare blacklisted (in case bid securing declaration is submitted) in which event the Procuring agency/Employer may make the award to the next most advantageous bidder or reinitiate the procurement process afresh (as a case may be).

7. Advance Payment

7.1. Advance payment will be provided to the bidder in percentage and in the manner as agreed by the both parties in terms of Conditions of the Contract.

7.2. The Procuring agency/Employer will provide an advance payment as stipulated in the Conditions of Contract, subject to a maximum amount, as stated and/or Conditions of the Contract. The advance payment request shall be accompanied by an advance payment security (guarantee) in the form provided in Section X. For the purpose of receiving the advance payment, the bidder shall make and estimate of, and include in its bid, the expenses that will relate to the purchase of equipment, machinery, materials, and on the engagement of labor during the first month beginning with the date of the Procuring agency/Employer's "**Notice to Commence**" as specified in the **PCC**.

8. General Performance of the Bidders

8.1. The Procuring agency/Employer reserves the right to obtain information regarding performance of the bidders on their previously awarded contracts / works. The Procuring agency/Employer may seek information / report from the previous employer for consideration. However, the Procuring agency/Employer shall incorporate such parameters in the evaluation criteria and accordingly decide the fate of the bid submitted.

9. Corrupt & Fraudulent Practices

9.1. Procuring agencies (including beneficiaries of Government funded projects and procurement) as well as Bidders/Suppliers/Contractors under Government financed contracts, observe the highest standard of ethics during the procurement and execution of such contracts, and will avoid to engage in any corrupt and fraudulent practices.

G. GRIEVANCE REDRESSAL & COMPLAINT REVIEW MECHANISM

1. Grievance Redressal

1.1. Grievance Redressal shall be carried out in accordance with the PP Rules 2025, rule no. 65 i.e. Redressal of grievances by the procuring agency and “Redressal of Grievances Regulations 2021”.

H. MECHANISM OF BLACKLISTING

1. Mechanism of Blacklisting

1.1. The Procuring agency/Employer shall proceed Blacklisting of Bidders/Contractors in accordance with PP Rules 2025, rule no.25 i.e. Blacklisting and “Blacklisting and Debarment of Bidders or Contractors Regulations 2024.



Bid Data Sheet


Bids Data Sheet (BDS)

The following specific data for the procurement of Goods to be procured shall complement, supplement, or amend the provisions in the Instructions to Bidders (ITB). Whenever there is a conflict, the provisions herein shall prevail over those in ITB.

BDS Clause Number	ITB Number	Amendments of, and Supplements to, Clauses in the Instruction to Bidders
A. Introduction		
1	1.1	<p>Name of Procuring Agency:Assets Management (North), NGC Islamabad (Chief Engineer Asset Management National Grid Company (NGC-Islamabad))</p> <p>The subject of procurement is:SHIFTING OF GUY WIRE FOUNDATIONS OF MICROWAVE TOWER AT 220KV GRID STATION SANGJANI DUE TO PASSAGE OF MARGALLA LINK ROAD FROM G.T ROAD (N-5) TO MOTORWAY M-1,(XEN-CIVIL-NGC-ISB-06/2025-26)</p> <p>Expected commencement date: Monday, May 4, 2026</p>
2.	2.1	<p>Financial year for the operations of the Procuring Agency:2025-26</p> <p>Name and identification number of the Contract: P11297</p>
3.	3.1	<p>JV/Consortium or Association Allowed: Yes</p> <p>Number of JV/Consortium Members: 2</p>

B. Bidding Documents

4.	6.2 & 6.4	The Bidders may seek clarifications through EPADS v2.0 : Clarification Date: Tuesday, March 17, 2026 Pre-Bid Meeting: Monday, March 16, 2026 11:00 AM Venue: 27 O/O Chief Engineer Asset Management, H-8/4
5.	7.2	Any addendum, in case issued, shall be published on Assets Management (North), NGC Islamabad (Chief Engineer Asset Management National Grid Company (NGC-Islamabad)) website and on EPADS v2.0 .
C. Preparation of Bids		

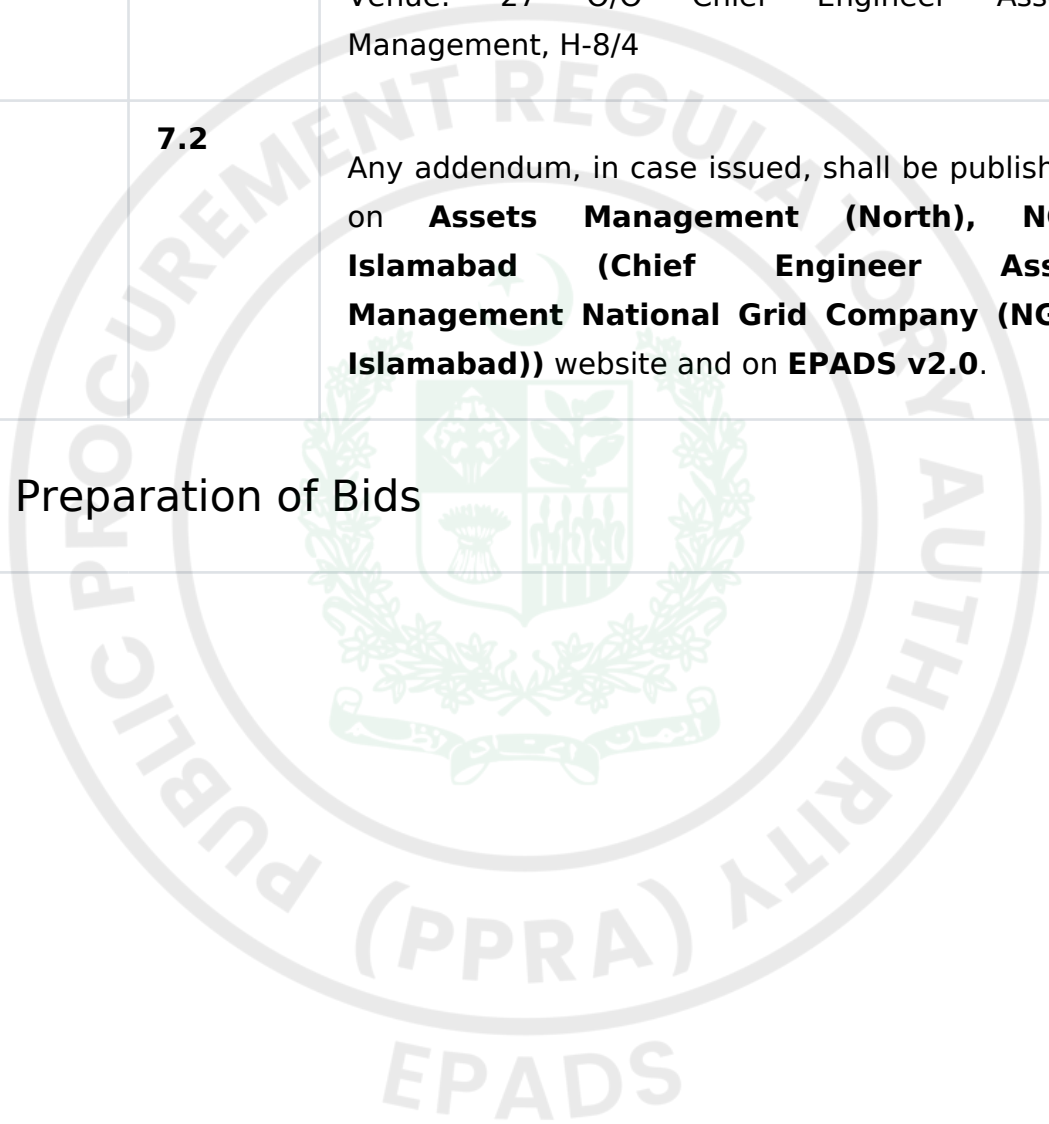

<p>6.</p>	<p>8.1</p>	<p>List of documents required along with the bid:</p> <ol style="list-style-type: none"> 1. Duly filled-in Form of Technical Bid with following Appendices to Bid:Appendix-A to Bid Special Stipulations Appendix-C to Bid Price Adjustment (under Clause 70) Appendix-E to Bid Proposed Construction ScheduleAppendix-F to Bid Method of Performing the WorkAppendix-G to Bid Proposed PersonnelAppendix-H to Bid List of Major Equipment-Related Items Appendix-I to Bid Construction Camp and Housing Facilities Appendix-J to Bid Organizational Chart of the Supervisory Staff and Labor 2. Appendix-K to Bid List of Sub-ContractorsAppendix-L to Bid Source of Materials Appendix-N to Bid DeviationsAppendix-O to Bid Integrity PactAppendix-P to Bid Bidder’s Qualification Forms 3. Bid Security as per IB Clause 15.1Written Power of Attorney, duly notarized, authorizing the signatory of the bid to act for and on behalf of the Bidder;Copies of Original Documents defining the constitution or legal status, place of registration and principal place of business of the bidder and JV partners;An affidavit that the Bidder has not been blacklisted pursuant to Sub-Clause 3.1(iv);An Affidavit that the Bidder has read and accepts NGC’s SOP for blacklisting of Contractors pursuan
<p>7.</p>	<p>9.1</p>	<p>The qualification criteria to establish the supply / production capability of the bidder.</p> <p><i>see Eligibility Criteria</i></p>

8.	11.2	Works and Their related documents: <i>See section Required Scope of Work</i>
9.	11.1	Price schedule will be provided according to the format defined and acquired. <i>see section price schedule.</i>
10.	11.4	Specifications: <i>see section of specifications.</i>
11.	11.5 & 13.5	The price shall be Fixed . The bid price shall be adjusted in accordance with Appendix provided - Formula for Price Adjustment.
12.	14.1	Currency of the Bids shall be : PKR
13.	16.1	The Bids/Bid Validity period shall be: 150 Days
14.	17.1	The amount of Bid Security shall be as defined in Bid Security Section for items and lots given in BDS 6
15.	17.2	The Bid Security shall be in the form of: Call at Deposit
16.	15.1	Alternative Bids to the requirements of the bidding documents will not be permitted.
D. Submission of Bids		

17.	18.1 & 21.1	<p>Bid shall be submitted online on EPADS v2.0 whereas hard copy of the bid security should be submitted to the following;</p> <p>27 O/O Chief Engineer Assest Management, H-8/4, Islamabad Capital Territory</p> <p>Bids that are not submitted on EPADS v2.0 shall be disqualified.</p> <p>The deadline for Bids submission is: Tuesday, March 31, 2026 11:00 AM</p>
E. Opening and Evaluation of Bids		
18.	24.1	<p>The Bids opening shall take place on EPADS v2.0.</p> <p>Day : Tuesday</p> <p>Date: March 31, 2026</p> <p>Time : 02:30 PM</p>
19.	30.2	<p>Selection technique adopted will be: Least Cost Based Selection (LCBS) <i>see Evaluation Criteria</i></p>
F. Award of Contract		
20.	41.1 & 41.2	<p>The Performance guarantee shall: 10.00%.</p> <p>The Performance Guarantee shall be acceptable in the form of: Call at Deposit, Bank Guarantee</p>
21.	45.1	<p>Arbitrator shall be appointed by mutual consent of the both parties.</p>

G. Review of Procurement Decisions

22.	37	Grievance against this procurement shall be submitted online on EPADS v2.0.
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Eligibility Criteria

Bidder's Type	Required Registration
Sole Proprietorship Partnership Firm Company (Private Limited) Company (Public Limited)	NADRA CITIZENSHIP (CNIC/NICOP) FBR (NTN) PEC

Evaluation Criteria

Least Cost Based Selection (LCBS)

Technical Marks	100
Passing Marks	70
Average annual turnover	
Upto 20 Million (Quantitative)(Doc Required)	20
Upto 15 million (Quantitative)(Doc Required)	15
Upto 14 million (Quantitative)(Doc Required)	10
Construction Experience	
up to 15 years (Quantitative)(Doc Required)	10
Upto 5-10 years (Quantitative)(Doc Required)	5

Techical staff	
1 professional engineer (civil) (Quantitative)(Doc Required)	10
1 Residential engineer (civil) (Quantitative)(Doc Required)	5
surveyor havivg minimum 5 years experience (Quantitative)(Doc Required)	5
1 residential engineer (Mechanical) (Quantitative)(Doc Required)	5
1 residential engineer (Electrical) (Quantitative)(Doc Required)	5
Construction Machinery	
Excavator (Quantitative)(Doc Required)	5
specialised shuttering and formwork (Quantitative)(Doc Required)	3
Concrete Mixing machine and Dumper (Quantitative)(Doc Required)	2

Related Services :

Yes

SHIFTING OF GUY WIRE FOUNDATIONS OF MICROWAVE TOWER AT 220KV GRID STATION SANGJANI DUE TO PASSAGE OF MARGALLA LINK ROAD FROM G.T ROAD (N-5) TO MOTORWAY M-1,(XEN-CIVIL-NGC-ISB-06/2025-26)

Job	Related Services
Civil Works	Site office,water bore hole and perimeter securing
Structure Works (Tower Guying Fixing)	PPE and mitigation & elimination of risks and hazards

Work Specifications and Market Rates

Lot Title: SHIFTING OF GUY WIRE FOUNDATIONS OF MICROWAVE TOWER AT 220KV GRID STATION SANGJANI DUE TO PASSAGE OF MARGALLA LINK ROAD FROM G.T ROAD (N-5) TO MOTORWAY M-1,(XEN-CIVIL-NGC-ISB-06/2025-26)

Specifications / Requirements:

Sr. No	Item	Description	Unit	Qty	Unit Rate (PKR)	Total Amount (PKR)	PRA Tax (16%)	Total Cost
1	1	Existing GYUMAST TOWER Strengthening survey for the assessment of present and proposed loading on the GYUMAST TOWER and its structural sufficiency to cater for these loadings under present condition. Drawings and calculations of the GYUMAST TOWER are not available with Client.	Job	1	150,000	150,000.00	24,000.00	174,000.00
2	2	Testing of GYUMAST TOWER material (Legs, diagonals & horizontals) with Proceq Equotip Hardness Tester	Job	1	175,000	175,000.00	28,000.00	203,000.00

Sr. No	Item	Description	Unit	Qty	Unit Rate (PKR)	Total Amount (PKR)	PRA Tax (16%)	Total Cost
3	3	Existing GYUMAST TOWER Strengthening Analysis for the assessment of present and proposed loading on the GYUMAST TOWER and its structural sufficiency to cater for these loadings under present condition. Drawings and calculations of the GYUMAST TOWER are not available with Client.	Per Vertical Meter	120	3,500	420,000.00	67,200.00	487,200.00
4	4	Existing GYUMAST TOWER Strengthening Design for the assessment of present and proposed loading on the GYUMAST TOWER and its structural sufficiency to cater for these loadings under present condition. Drawings and calculations of the GYUMAST TOWER are not available with Client.	Per Vertical Meter	120	2,500	300,000.00	48,000.00	348,000.00

Sr. No	Item	Description	Unit	Qty	Unit Rate (PKR)	Total Amount (PKR)	PRA Tax (16%)	Total Cost
5	5	Excavation (3 Anchors)	m ³	65	1500	97,500.00	15,600.00	113,100.00
6	6	RCC for Guy Anchors class A	m ³	56	50,500	2,828,000.00	452,480.00	3,280,480.00
7	7	Reinforcement Steel G60	kg	1250	575	718,750.00	115,000.00	833,750.00
8	8	Formwork & Shuttering	Job	1	175,000	175,000.00	28,000.00	203,000.00
9	9	General cost Mobilization includes but not limited to site cleaning, demolition, chiseling, and removal and disposal of debris	Site	1	300,000	300,000.00	48,000.00	348,000.00
10	10	Concrete Arrangement includes Lift/Mixer etc.	Site	1	175,000	175,000.00	28,000.00	203,000.00
11	11	Anchor Template Installation	Lot	3	195,000	585,000.00	93,600.00	678,600.00
12	12	Turnbuckles, Shackles, Thimbles, Clips existing also be used	Lot	3	250,000	750,000.00	120,000.00	870,000.00
13	13	Anchor Rod Assemblies (HDG)	sets	3	375,000	1,125,000.00	180,000.00	1,305,000.00
14	14	Hardware (bolts, nuts, washers)	Lot	3	245,000	735,000.00	117,600.00	852,600.00

Sr. No	Item	Description	Unit	Qty	Unit Rate (PKR)	Total Amount (PKR)	PRA Tax (16%)	Total Cost
15	15	Guy Wire Installation	Job	1	400,000	400,000.00	64,000.00	464,000.00
16	16	Guy Tensioning & Alignment	Job	1	275,000	275,000.00	44,000.00	319,000.00
17	17	Verticality Test	Job	1	150,000	150,000.00	24,000.00	174,000.00
18	18	Guy Tension Verification	Job	1	175,000	175,000.00	28,000.00	203,000.00
19	19	Tightening of existing guy mast tower	meter	120	3,000	360,000.00	57,600.00	417,600.00
20	20	Guy Wire Inspection Using MFL NDT Methode	Job	1	475,000	475,000.00	76,000.00	551,000.00
21	21	On-line measurement of Tension of Guy Wire Strands by Tension Meter	Job	1	350,000	350,000.00	56,000.00	406,000.00
22	22	Transportation cost of material and labor	Job	1	195,000	195,000.00	31,200.00	226,200.00
23	23	Steel Test Report	Job	1	235,000	235,000.00	37,600.00	272,600.00
24	24	Concrete Test Report	Job	1	250,000	250,000.00	40,000.00	290,000.00
25	25	Structure Stability Certificate	Job	1	375,000	375,000.00	60,000.00	435,000.00
							GRAND TOTAL:	Rs13,658,130.00

Scope of Work

1. Careful dismantling of existing guy wire foundation(s) without disturbing existing microwave tower alignment and telecom services.
2. Excavation, reinforcement, concreting, curing and construction of one primary shifted foundation along with two corresponding associated guy wire foundations required to maintain tower stability.
3. Simultaneous shifting, re-fixing and re-alignment of total three (03) related guy wire foundations ensuring structural equilibrium of microwave tower.
4. Re-tensioning and balancing of all affected guy wires after foundation shifting.
5. Submission of revised structural design and tower strength report using STAAD.Pro / SAP2000 / ETABS / ASMTOWER.
6. Submission of structural health certificate before and after execution.
7. Provision of written guarantee regarding tower healthiness.

Price Schedule

For Individual Jobs

#	Job Title	Quantity	Unit Price (PKR)	Total Price (PKR)	Delivery Location	Delivery Period / Year	Country of Origin
1							
2							

For Lots

#	Lot Title	Total Lot Price (PKR)	Country of Origin
1	[Lot 1 Title]		







General Conditions of Contract

A. General

1. Definitions

1.1. Unless the context otherwise requires, the following terms whenever used in this Contract shall have the same meaning and shall be interpreted as indicated

1.1.1. "Applicable Law" means the laws and any other instruments having the force of law in the Government's Country, or in such other country as may be specified in the Special Conditions of the Contract (SC), as they may be issued and in force from time to time;

1.1.2. "The Contract" means an agreement enforceable by law;

1.1.3. "The Contract Price" means the price payable to the Contractor under the Contract for the full and proper performance of its contractual obligations;

1.1.4. "The Services" means the work to be performed by the Contractor pursuant to this Contract and as prescribed in the Specifications and Schedule of Activities included in the Contractor's Bid;

1.1.5. "Ancillary Services" means those services ancillary to the provision of Services, such as transportation and insurance, and any other incidental services, such as installation, commissioning, provision of technical assistance, training, and other such obligations of the Contractor covered under the Contract;

1.1.6. "GCC" means the General Conditions of Contract contained in this section;

1.1.7. "SCC" means the Special Conditions of Contract by which the GCC may be amended or supplemented;

1.1.8. "Day" means calendar day unless indicated otherwise;

1.1.9. "Effective Date" means the date on which this Contract comes into force and effect;

1.1.10. "The Contractor" means the individual or corporate body whose Bids to provide the Services has been accepted by the Procuring Agency;

1.1.11. "The Project Site," where applicable, means the place or places named in Bid Data Sheet and technical Specifications;

1.1.12. "Government" means the Government of Pakistan;

1.1.13. "Local Currency" means the currency of Pakistan;

1.1.14. "In Writing" means communicated in written form with proof of receipt;

1.1.15. "Completion Date" means the date of completion of the Services by the Contractor as certified by the Procuring Agency;

1.1.16. "Foreign Currency" means any currency other than the currency of the country of the Procuring Agency;

1.1.17. "Party" means the Procuring Agency or the Contractor, as the case may be, and "Parties" means both of them;

1.1.18. "Service" means any object of procurement other than goods or works;

1.1.19. "Subcontractor" means any entity to which the Bidder subcontracts any part of the Services.

2. **Applicable Law**

2.1. The contract shall be governed and interpreted in accordance with the laws of Pakistan, unless otherwise specified in SCC.

3. **Language**

3.1. The Contract as well as all correspondence and documents relating to the Contract exchanged between the Contractor and the Procuring Agency, shall be written in the **English language** unless otherwise stated in the SCC. Supporting documents and printed literature that are part of the Contract may be in another language provided these are accompanied by an accurate translation of the relevant passages in English, in which case, for purposes of interpretation of the Contract, this translation shall govern.

4. **Notices**

4.1. Any notice, request, or consent made pursuant to this Contract shall be in writing and shall be deemed to have been made when delivered in person to an authorized representative of the Party to whom the communication is addressed, or when sent by registered mail, telex, telegram, or facsimile to such Party at the address specified in the SCC.

5. **Location**

5.1. The Services shall be performed at such locations as the Procuring Agency may approve and as specified in SCC.

5.2. A {DOCUMENTS}

6. **Authorized Representatives / Authority of Member in charge**

6.1. Any action required or permitted to be taken, and any document required or permitted to be executed, under this Contract by the Procuring Agency or the Contractor may be taken or executed by the officials specified in the SCC.

B. **Commencement, Completion, Modification, and Termination of Contract**

1. **Effectiveness of Contract**

1.1. This Contract shall come into effect on the date the Contract is signed by both parties and such other later date as may be stated in the SCC.

2. Commencement of Services

2.1. The Contractor shall confirm availability of Key Experts and begin carrying out the Services not later than the number of days after the Effective Date specified in the SCC.

3. Program schedule

3.1. Before commencement of the Services, the Contractor shall submit to the Procuring Agency for approval a Program showing the general methods, arrangements, order and timing for all activities. The Services shall be carried out in accordance with the approved Program as updated.

4. Starting Date/Expiration Date

4.1. The Contractor shall start carrying out the Services Five (05) days after the date the Contract becomes effective, or at such other date as may be specified in the SCC.

4.2. Unless terminated earlier pursuant to Clause **GCC 14** hereof, this Contract shall expire at the end of such time period after the Effective Date as specified in the SCC.

5. Entire Agreement

5.1. This Contract contains all covenants, stipulations and provisions agreed by the Parties. No agent or representative of either Party has authority to make, and the Parties shall not be bound by or be liable for, any statement, representation, promise or agreement not set forth herein.

6. Modification

6.1. Any modification or variation of the terms and conditions of this Contract, including any modification or variation of the scope of the Services, may only be made by written agreement between the Parties. However, each Party shall give due consideration to any modification(s) or variation(s) made by the other Party.

6.2. In cases of any modification(s) or variation(s), the prior written consent of the Procuring Agency is required.

7. Force Majeure

7.1. Definition

For the purposes of this Contract, "Force Majeure" means an event which is beyond the reasonable control of a Contractor and which makes a Contractor's performance of its obligations under the Contract impossible or so impractical as to be considered impossible under the circumstances.

7.2. No Breach of Contract

The failure of a Party to fulfill any of its obligations under the contract shall not be considered to be a breach of, or default under, this Contract in so far as such inability arises from an event of Force Majeure, provided that the Party affected by such an event (a) has taken all reasonable precautions, due care and reasonable alternative

measures in order to carry out the terms and conditions of this Contract, and (b) has informed the other Party as soon as possible about the occurrence of such an event.

7.3. Extension of Time

Any period within which a Contractor shall, pursuant to this Contract, complete any action or task, shall be extended for a period equal to the time during which such Party was unable to perform such action as a result of Force Majeure.

7.4. Payments

During the period of their inability to perform the Services as a result of an event of Force Majeure, the Contractor shall be entitled to continue to be paid under the terms of this Contract, as well as to be reimbursed for additional costs reasonably and necessarily incurred by them during such period for the purposes of the Services and in reactivating the Service after the end of such period.

8. Termination

8.1. By the Procuring Agency

The Procuring Agency may terminate this Contract in case of the occurrence of any of the events specified in paragraphs (a) through (e) of this Clause. In such an occurrence the Procuring Agency shall give at least thirty (30) calendar days' written notice of termination to the Contractor in case of the events referred to in (a) through (d); at least sixty (60) calendar days' written notice in case of the event referred to in (e);

8.1.1. If the Contractor fails to remedy a failure in the performance of its obligations hereunder, as specified in a notice of suspension;

8.1.2. If the Contractor becomes (or, if the Contractor consists of more than one entity, if any of its members becomes) insolvent or bankrupt or enter into any agreements with their creditors for relief of debt or take advantage of any law for the benefit of debtors or go into liquidation or receivership whether compulsory or voluntary;

8.1.3. If the Contractor fails to comply with any final decision reached as a result of arbitration proceedings;

8.1.4. If, as the result of Force Majeure, the Contractor is unable to perform a material portion of the Services for a period of not less than sixty (60) calendar days;

8.1.5. If the Procuring Agency, in its sole discretion and for any reason whatsoever, decides to terminate this Contract;

8.2. By the Contractor

The Contractor may terminate this Contract, by not less than thirty (30) calendar days' written notice to the Procuring Agency, in case of the occurrence of any of the events specified in paragraphs (a) through (d) of this Clause.

8.2.1. If the Procuring Agency fails to pay any money due to the Contractor pursuant to this Contract and not subject to dispute within forty-five (45) calendar days after receiving written notice from the Contractor that such payment is overdue;

8.2.2. If, as the result of Force Majeure, the Contractor is unable to perform a material portion of the Services for a period of not less than sixty (60) calendar days;

8.2.3. If the Procuring Agency fails to comply with any final decision reached as a result of arbitration;

8.2.4. If the Procuring Agency is in material breach of its obligations pursuant to this Contract and has not remedied the same within forty-five (45) days (or such longer period as the Bidder may have subsequently approved in writing) following the receipt by the Procuring Agency of the Contractor's notice specifying such breach.

C. Obligations of the Contractor

1. General

1.1. Standard of Performance

1.1.1. The Contractor shall perform the Services and carry out the Services with all due diligence, efficiency and economy, in accordance with generally accepted professional standards and practices, and shall observe sound management practices, and employ appropriate technology and safe and effective equipment, machinery, materials and methods. The Contractor shall always act, in respect of any matter relating to this Contract or to the Services, as a faithful adviser to the Procuring Agency, and shall at all times support and safeguard the Procuring Agency's legitimate interests in any dealings with the third parties;

1.1.2. The Contractor shall employ and provide such qualified and experienced Experts and Sub-Contractors as are required to carry out the Services.

1.2. Law Applicable to Services

The Contractor shall perform the Services in accordance with the Contract and in accordance with the Law of Pakistan and shall take all practicable steps to ensure that any of its Experts and Sub-Bidders, comply with the Applicable Law.

2. Conflict of Interests

2.1. Contractor Not to Benefit from Commissions and Discounts

The remuneration of the Contractor shall constitute the Contractor's sole remuneration in connection with this Contract or the Services, and the Contractor shall not accept for their own benefit any trade commission, discount, or similar payment in connection with activities pursuant to this Contract or to the Services or in the discharge of their obligations under the Contract, and the Contractor shall use their best efforts to ensure that the Personnel, any Subcontractors, and agents of either of them similarly shall not receive any such additional remuneration.

2.2. Contractor and Affiliates Not to be Otherwise Interested in Project

The Contractor agree that, during the term of this Contract and after its termination, the Contractor and its affiliates, as well as any Subcontractor and any of its affiliates, shall be disqualified from providing Services (other than the Services and any continuation thereof) for any project resulting from or closely related to the Services.

2.3. Prohibition of Conflicting Activities

Neither the Bidder nor its Subcontractors nor the Personnel shall engage, either directly or indirectly, in any of the following activities:

- 2.3.1. during the term of this Contract, any business or professional activities in the Government's country which would conflict with the activities assigned to them under this Contract;
- 2.3.2. during the term of this Contract, neither the Contractor nor their Subcontractors shall hire public employees in active duty or on any type of leave, to perform any activity under this Contract;
- 2.3.3. after the termination of this Contract, such other activities as may be specified in the **SCC**.

3. Insurance to be Taken Out by the Contractor

3.1. The Contractor(a) shall take out and maintain, and shall cause any Subcontractors to take out and maintain, at its (or the Sub-contractors', as the case may be) own cost but on terms and conditions approved by the Procuring Agency, insurance against the risks, and for the coverage, as shall be specified in the **SCC**; and (b) at the Procuring Agency's request, shall provide evidence to the Procuring Agency showing that such insurance has been taken out and maintained and that the current premiums have been paid.

4. Contractor's Actions Requiring Procuring Agency's Prior Approval

4.1. The Contractor shall obtain the Procuring Agency's prior approval in writing before taking any of the following actions:

- 4.1.1. appointing such members of the Personnel not provided by the Contractor;
- 4.1.2. changing the Program of activities; and
- 4.1.3. any other action that may be specified in the **SCC**.

5. Reporting Obligations

5.1. The Contractor shall submit to the Procuring Agency the reports and documents in the numbers, and within the periods as prescribed by the Procuring Agency.

6. Liquidated Damages

6.1. Payments of Liquidated Damages

The Contractor shall pay liquidated damages to the Procuring Agency at the rate per day stated in the **SCC** for each day that the Completion Date is later than the Intended Completion Date. The total amount of liquidated damages shall not exceed the amount defined in the **SCC**. The Procuring Agency may deduct liquidated damages from payments due to the Contractor. Payment of liquidated damages shall not affect the Contractor's liabilities.

6.2. Correction for Over-payment

If the Intended Completion Date is extended after liquidated damages have been paid, the Procuring Agency shall correct any overpayment of liquidated damages by the Contractor by adjusting the next payment certificate. The

Contractor shall be paid interest on the overpayment, calculated from the date of payment to the date of repayment, at the rates specified in **SCC**.

6.3. Lack of performance penalty

If the Contractor has not corrected a Defect within the time specified in the Procuring Agency's notice, a penalty for Lack of performance will be paid by the Contractor. The amount to be paid will be calculated as a percentage of the cost of having the Defect corrected, assessed as specified in the Contractor

7. Performance Guarantee

7.1. Within the time stipulated in the acceptance letter from the Procuring Agency, the successful Bidder shall furnish the Performance Guarantee in shape and amount **specified in SCC**.

7.2. The proceeds of the Performance Guarantee shall be payable to the Procuring agency as compensation for any loss resulting from the Supplier's failure to complete its obligations under the Contract.

7.3. The Performance Guarantee shall be denominated in the currency of the Contract, or in a freely convertible currency acceptable to the Procuring agency and shall be in the acceptable form as specified in **SCC**.

7.4. The Performance Guarantee will be discharged by the Procuring agency and returned to the Supplier not later than thirty (30) days following the date of completion of the Supplier's performance obligations under the Contract, including any warranty obligations, unless otherwise **specified in SCC**.

8. Sustainable Procurement

8.1. The Contractor shall conform to the sustainable procurement contractual provisions, if and as specified in the **SCC**.

D. Contractor's Personnel

1. Description of Personnel

1.1. The titles, agreed job descriptions, minimum qualifications, and estimated periods of engagement in the carrying out of the Services of the Contractor's Key Personnel. The Key Personnel listed by title as well as by name are hereby approved by the Procuring Agency.

2. Removal and / or Replacement of Personnel

2.1. Except as the Procuring Agency may otherwise agree, no changes shall be made in the Key Personnel. If, for any reason beyond the reasonable control of the Contractor, it becomes necessary to replace any of the Key Personnel, the Contractor shall provide as a replacement a person of equivalent or better qualifications.

2.2. If the Procuring Agency finds that any of the Personnel have (i) committed serious misconduct or have been charged with having committed a criminal action, or (ii) have reasonable cause to be dissatisfied with the performance of any of the Personnel, then the Contractor shall, at the Procuring Agency's written request specifying the grounds thereof, provide as a replacement a person with qualifications and experience acceptable to the Procuring Agency.

2.3. The Contractor shall have no claim for additional costs arising out of or incidental to any removal and/or replacement of Personnel.

E. Obligations of the Procuring Agency

1. Change in the Applicable Law

1.1. If, after the date of this Contract, there is any change in the Applicable Law with respect to taxes and duties which increases or decreases the cost of the Services rendered by the Contractor, then the remuneration and reimbursable expenses otherwise payable to the Contractor under this Contract shall be increased or decreased accordingly by agreement between the Parties, and corresponding adjustments shall be made to the amounts referred in the SCC.

2. Services and Facilities

2.1. The Procuring Agency shall make available to the Contractor and the Experts, for the purposes of the Services and free of any charge, the services, facilities and property described in the Terms of Reference, at the times and in the manner specified in the Terms of Reference.

2.2. In case that such services, facilities and property shall not be made available to the Contractor, the Parties shall agree on (i) any time extension that it may be appropriate to grant to the Contractor for the performance of the Services, (ii) the manner in which the Contractor shall procure any such services, facilities and property from other sources, and (iii) the additional payments, if any, to be made to the Contractor as a result thereof.

F. Payments to the Contractor

1. Contract Price

1.1. The price payable shall be in Pakistani Rupees unless otherwise specified in the SCC.

2. Terms and Conditions of Payment

2.1. Payments will be made to the Contractor according to the payment schedule stated in the SCC and as per actual invoice submitted by the Contractor.

2.2. Unless otherwise stated in the SCC, the advance payment shall be made against the provision by the Contractor of a bank guarantee for the same amount, and shall be valid for the period stated in the SCC. Any other payment shall be made after the conditions listed in the SCC for such payment have been met, and the Contractor have submitted an invoice to the Procuring Agency specifying the amount due.

3. Quality Control Identifying Defects

3.1. The principle and modalities of Inspection of the Services by the Procuring Agency shall be as indicated in the SCC. The Procuring Agency shall check the Contractor's performance and notify him of any Defects that are

found. Such checking shall not affect the Contractor's responsibilities. The Procuring Agency may instruct the Contractor to search for a Defect and to uncover and test any service that the Procuring Agency considers may have a Defect. Defect Liability Period is as defined in the **SCC**.

3.2. A {INSPECTION}

4. Correction of Defects, and Lack of Performance Penalty

4.1. The Procuring Agency shall give notice to the contractor of any Defects before the end of the Contract. The Defects liability period shall be extended for as long as Defects remain to be corrected.

4.2. Every time notice a Defect is given; the contractor shall correct the notified Defect within the length of time specified by the Procuring Agency's notice.

4.3. If the contractor has not corrected a Defect within the time specified in the Procuring Agency's notice, the Procuring Agency will assess the cost of having the Defect corrected, the contractor will pay this amount, and a Penalty for Lack of Performance.

5. Settlement of Disputes Amicable Settlement

5.1. The Parties shall use their best efforts to settle amicably all disputes arising out of or in connection with this Contract or its interpretation.

6. Dispute Settlement

6.1. Arbitration

If any dispute of any kind whatsoever shall arise between the procuring agency and the contractor in connection with or arising out of the Contract, including without prejudice to the generality of the foregoing, any question regarding its existence, validity or termination, or the execution of the contract, the parties shall seek to resolve any such dispute or difference by mutual consultation. If the parties fail to resolve such a dispute or difference even after negotiations or mediation, then the dispute shall be referred within fourteen (14) days in writing by either party to the Arbitrator, with a copy to the other party.

Any dispute in respect of which a notice of intention to commence arbitration has been given, in accordance with **GCC sub-clause 32.1**, shall be finally settled by arbitration. Arbitration may be commenced prior to or after completion of the Contract. Arbitration proceedings shall be conducted in accordance with Arbitration Act 1940. Notwithstanding any reference to arbitration herein, the parties shall continue to perform their respective obligations under the Contract unless otherwise agreed. The Procuring Agency shall continue to pay the Contractor any undisputed amounts due under the Contract during the resolution of any dispute.



Special Conditions of Contract

SECTION VIII. SPECIAL CONDITIONS OF CONTRACT

The following Special Conditions of Contract shall supplement the General Conditions of Contract. Whenever there is a conflict, the provisions herein shall prevail over those in the Conditions of Contract. The corresponding clause number of the GCC is indicated in parentheses.

Number of GC Clause	Amendments of, and Supplements to, Clauses in the General Conditions of Contract
	<p>Definitions</p> <p>The Procuring Agency is: Assets Management (North), NGC Islamabad (Chief Engineer Asset Management National Grid Company (NGC-Islamabad)), Deputy Manager 27 O/O Chief Engineer Assest Management, H-8/4, Islamabad Capital Territory</p> <p>The Supplier is:</p> <p>The title of the subject procurement is: SHIFTING OF GUY WIRE FOUNDATIONS OF MICROWAVE TOWER AT 220KV GRID STATION SANGJANI DUE TO PASSAGE OF MARGALLA LINK ROAD FROM G.T ROAD (N-5) TO MOTORWAY M-1, (XEN-CIVIL-NGC-ISB-06/2025-26)</p>
GCC 2	<p>Applicable/Governing Law:</p> <p>The Contract shall be interpreted in accordance with the laws of Islamic Republic of Pakistan</p>
GCC 3	<p>Language:</p> <p>The language of the Contract, all correspondence and communications to be given, and all other documentation to be prepared and supplied under the Contract shall be in English.</p>

<p>GCC 4</p>	<p>Notices:</p> <p>The addresses for the notices are:</p> <p>Procuring Agency:</p> <p>Assets Management (North), NGC Islamabad (Chief Engineer Asset Management National Grid Company (NGC-Islamabad)),Deputy Manager 27 O/O Chief Engineer Assest Management, H-8/4, Islamabad Capital Territory +92-335-740-2521 engrburki@ntdc.com.pk</p> <p>Contractor/ Bidder:</p> <p>[Name, address and telephone number].</p> <p>The Contractor/ Bidder’s Representative(s)</p> <p>[Name, address, telephone number and e-mail address]</p>
<p>GCC 6.1</p>	<p>The Authorized Representatives are:</p> <p>For the Procuring Agency:</p> <p>Assets Management (North), NGC Islamabad (Chief Engineer Asset Management National Grid Company (NGC-Islamabad)),Deputy Manager 27 O/O Chief Engineer Assest Management, H-8/4, Islamabad Capital Territory +92-335-740-2521 engrburki@ntdc.com.pk</p> <p>For the Bidder:</p> <p>Name:</p> <p>Designation:</p> <p>Address:</p>
<p>GCC 7</p>	<p>Effectiveness of the contract</p> <p>The Contractor/Bidder shall be effective within days from the date of signature of the Contract by both parties</p>
<p>GCC 8</p>	<p>Commencement of Contract:</p> <p>The Contractor/ Bidder shall provide Non-Consultancy Services from the effective date of contract.</p>

<p>GCC 10.2</p>	<p>Expiration of Contract:</p> <p>The time period shall be</p>
<p>GCC 14</p>	<p>Termination</p> <p>In the event of termination of the contract due to any reason as already defined in the General Conditions of Contract, the Bidder shall be responsible for providing to the Authority the Goods till the time of alternate arrangements.</p>
<p>GCC 16</p>	<p>Conflict of Interest:</p> <p>The Procuring Agency reserves the right to determine on a case-by-case basis whether the Bidder should be disqualified from providing goods or services due to a conflict of a nature described in Clause GCC 17.</p>
<p>GCC 20</p>	<p>Liquidated Damages</p> <p>If the Bidder fails to provide services as required under the contract or in case of any data loss/data breach or any incident compromising the data security or other such failures related to any services, the Bidder shall pay to the Procuring Agency as Liquidated Damages at a rate of 0.10% to 10.00% of the Contract value, in accordance with the extent of performance failure & the cost of investigating such incidents as judged by the Authority.</p>
<p>GCC 21</p>	<p>Performance Guarantee:</p> <p>The amount of performance guarantee shall be 10.00% of the contract price in acceptable form of Call at Deposit, Bank Guarantee</p>
<p>GCC 27</p>	<p>Currency of Payment:</p> <p>All the payment to be released to the contractor/Bidder shall be in Pakistani Rupees.</p>
<p>GCC 28</p>	<p>Payment terms:</p> <p>Payment will be made to the Bidder against the procured Goods and services according to the actual invoice or running bills submitted by the Bidder against the services provided within the time given in the conditions of the contract.</p>

GCC 29**Identifying Defects:**

The Authority reserves the right at any time to inspect the premises of the provider to inspect the goods and monitor the goods being provided.

Inspections & Tests Requirements

For being Brand New, bearing relevant reference numbers of the equipment (Certificate from supplier)

For Physical Fitness having No Damages (Certificate from supplier)

For the Country of Origin as quoted by the Supplier (Certificate from manufacturer)

For conformance to specifications and performance parameters, through Prior to delivery inspection (Inspection Report by Procurement Committee / Inspection Team)

For successful operation at site after complete installation, testing and commissioning of the equipment (Installation, Testing and Commissioning Report by Procurement Committee / Inspection Team)

Delivery & Documents

Copies of the Supplier's invoice showing Goods' description, quantity, unit price, and total amount;

Insurance Certificate;

Manufacturer's or Supplier's Valid Warranty Certificate;

Inspection Certificate issued by the Nominated Inspection Agency (if any), and the Supplier's Factory Inspection Report;

Certificate of Origin.

The above documents would be required even if the equipment has already been imported and is available with the supplier ex-stock

Following is the guidance for Dispute Resolution

1. If any dispute of any kind whatsoever shall arise between the Authority and the Bidder in connection with or arising out of the Contract, including without prejudice to the generality of foregoing, any question regarding its existence, validity, termination and the execution of the Contract – whether during developing phase or after their completion and whether before or after the termination, abandonment or breach of the Contract – the parties shall seek to resolve any such dispute or difference by mutual diligent negotiations in good faith within 14 (fourteen) days following a notice sent by one Party to the other Party in this regard.
2. At future of negotiation the dispute shall be resolved through mediation and mediator shall be appointed with the mutual consent of the both parties.
3. At the event of failure of mediation to resolve the dispute relating to this contract such dispute shall finally be resolved through binding Arbitration by sole arbitrator in accordance with Arbitration Act 1940. The arbitrator shall be appointed by mutual consent of the both parties. The Arbitration shall take place in Islamabad, Pakistan and proceedings will be conducted in English language.
4. The cost of the mediation and arbitration shall be shared by the parties in equal proportion however the both parties shall bear their own costs and lawyer's fees regarding their own participation in the mediation and arbitration. However, the Arbitrator may make an award of costs upon the conclusion of the arbitration making any party to the dispute liable to pay the costs of another party to the dispute.
5. Arbitration proceedings as mentioned in the above clause regarding resolution of disputes may be commenced prior to, during or after completion of the contract.

Notwithstanding any reference to the arbitration herein, the parties shall continue to perform their respective obligations under the Contract unless they otherwise agree that the Authority shall pay the Bidder any monies due to the Bidder.

Arbitrator's fee:

The fee shall be specified in Pak Rupees, as determined by the Arbitrator, which shall be shared equally by both parties.

Appointing Authority for Arbitrator:

By the Mutual Consent or in accordance with the provisions of Arbitration Act, 1940, in case the parties fail to reach a consensus on the name of sole arbitrator, any party may submit an application to the Chief Justice Islamabad High Court for appointment of sole arbitrator. The Chief Justice IHC may appoint a former judge of any High Court or Supreme Court as the sole arbitrator to resolve the dispute between the parties.

Rules of procedure for arbitration proceedings:

Any dispute between the Authority and a Bidder who is a national of the Islamic Republic of Pakistan arising in connection with the present Contract shall be referred to adjudication or arbitration in accordance with the laws of the Islamic Republic of Pakistan including Arbitration Act 1940, however above provision shall prevail in referring the case to the Arbitrator.

Place of Arbitration and Award:

The arbitration shall be conducted in English language and place of arbitration shall be at



Bid Securing Declaration





Contract Form





Integrity Pact





Performance Guarantee Form





Annexure

Drawings

Upload Document

Document Required

See Form Under Additional Forms and Documents: **Drawings** (page number: 77)





Procurement Forms

Past Experience and Completed Contracts

please fill,sign,stamp and submit.

See Form Under Additional Forms and Documents: **Past Experience and Completed Contracts** (page number: 97)

Historical Contract Non-Performance, and Pending Litigation and Litigation History

please fill,sign,stamp and submit.

See Form Under Additional Forms and Documents: **Historical Contract Non-Performance, and Pending Litigation and Litigation History** (page number: 98)

Current Contracts and Their Progress

please fill,sign,stamp and submit.

See Form Under Additional Forms and Documents: **Current Contracts and Their Progress** (page number: 100)

Financial Capacity and Net Worth Evaluation Form

please fill,sign,stamp and submit.

See Form Under Additional Forms and Documents: **Financial Capacity and Net Worth Evaluation Form** (page number: 101)

Average Annual Turnover

please fill,sign,stamp and submit.

See Form Under Additional Forms and Documents: **Average Annual Turnover** (page number: 103)





Additional Forms and Documents

PROJECT NAME: ADB-202R-2019: PROCUREMENT OF PLANT, DESIGN, SUPPLY,
INSTALLATION, TESTING, AND COMMISSIONING OF SCADA
PHASE-3 AND REVENUE METERING SYSTEM (RMS)
NTDC LOAN NO.3577-PAK: SECOND POWER TRANSMISSION
INVESTMENT PROGRAM, TRANCHE-2

SITE ID: ISPR 220KV

SITE ADDRESS: 220 KV GRID STATION ISLAMABAD
PESHAWAR .

120M GUYED MAST TOWER

EMPLOYER:



**NATIONAL TRANSMISSION
& DESPATCH COMPANY LIMITED**

CONSULTANT:



CONTRACTOR:



SUBCONTRACTOR:



HUAWEI TECHNOLOGIES CO.LTD.

LIST OF DRAWING

DRAWING NO.	DRAWING TITLE
CIVIL DRAWINGS	
LDP-III-A-SR116-DWG-GN-01	MICROWAVE STATION GENERAL NOTES
LDP-III-A-SR116-DWG-0001	MICROWAVE STATION EXISTING SITE LOCATION PLAN
LDP-III-A-SR116-DWG-0002	MICROWAVE STATION PROPOSED SITE LOCATION PLAN
LDP-III-A-SR116-DWG-0003	MICROWAVE STATION PROPOSED LAYOUT PLAN
LDP-III-A-SR116-DWG-0004	MICROWAVE STATION GUYED MAST BASE FOUNDATION DETAILS
LDP-III-A-SR116-DWG-0004A	MICROWAVE STATION GUYS BASE FOUNDATION DETAILS
LDP-III-A-SR116-DWG-0004B	MICROWAVE STATION GUYS BASE FOUNDATION DETAILS LIST
LDP-III-A-SR116-DWG-0005	MICROWAVE STATION HUT PLAN VIEW / HUT ROOF TOP PLAN
LDP-III-A-SR116-DWG-0006	MICROWAVE STATION HUT SECTION & DETAILS
LDP-III-A-SR116-DWG-0007	MICROWAVE STATION HUT PLAN VIEW / HUT BY FACE ELEVATION
LDP-III-A-SR116-DWG-0008	MICROWAVE STATION HUT FOUNDATION DETAILS
LDP-III-A-SR116-DWG-0009	MICROWAVE STATION HUT ROOF SLAB REINFORCEMENT PLAN & DETAILS
LDP-III-A-SR116-DWG-0010	MICROWAVE STATION LINTEL BEAM REINFORCEMENT DETAIL
LDP-III-A-SR116-DWG-0011	MICROWAVE STATION HUT PROPOSED DOOR DETAILS
LDP-III-A-SR116-GM/120M/BASE-01	MICROWAVE STATION STUB & BASE PLATE DETAILS
LDP-III-A-SR116-GM/120M/TEMP-01	MICROWAVE STATION BASE TEMPLATE [01 & 02]
ELECTRICAL & EARTHING DRAWINGS	
LDP-III-A-SR116-DWG-E001	MICROWAVE STATION HUT ELECTRICAL LAYOUT PLAN
LDP-III-A-SR116-DWG-E002	MICROWAVE STATION PROPOSED CABLE ROUTING SITE LAYOUT PLAN

LIST OF LEGEND:

S#	SYMBOL	DESCRIPTION
1		BOUNDARY WALL
2		LEVEL MARK
3		GRASS
4		WAPDA POLE
5		GATE
6		FENCE
7		EARTH PIT
8		SOLAR SYSTEM PLATES
9		DG PAD
10		DOOR
11		CABLE TRAY
12		POWER CABLE
13		HUT SHADE
14		EXISTING 11KV LINE
15		EXISTING CABLE TRENCH

LIST OF ABBREVIATIONS

S#	ABBREVIATIONS	DESCRIPTION
1	EGL	EXISTING GROUND LEVEL
2	PL	PLITH LEVEL
3	RL	ROAD LEVEL
4	ERL	EXISTING ROAD LEVEL
5	FGL	FINISHED GROUND LEVEL
6	FFL GHT	FINISHED FLOOR LEVEL
7	GL	GROUND LEVEL
8	WL	WATER LEVEL
9	MAX	MAXIMUM
10	MIN	MINIMUM
11	AVG	AVERAGE
12	SL	STRUCTURAL LEVEL
13	KV	KILO VOLTS
14	AC	ALTERNATING CURRENT
15	DC	DIRECT CURRENT
16	CC	CEMENT CONCRETE
17	FF	FLOOR FINISH
18	T.B	TOP/BOTTOM
19	W/C	WATER CEMENT RATIO
20	OPC	ORIDNARY PORTLAND CEMENT
21	CS PLASTER	CEMENT SAND PLASTER
22	S.S GRATING	STAINLESS STEEL GRATING
23	PVC	POLYVINYL CHLORIDE
24	PCC	PLAIN CEMENT CONCRETE
25	RCC	REINFORCED CEMENT CONCRETE
26	DPC	DAMP PROOF COURSE
27	ODU	OUT DOOR UNIT
28	CDH	CABLE DUCT HOLE
29	RMS	REVENUE METERING SYSTEM
30	SOG	SLAB ON GRADE
31	MS	MILD STEEL
32	BTS	BASE TRANSCEIVER STATION
33	ACDB	ALTERNATING CURRENT DISTRIBUTION BOX
34	OB LIGHT	OBSTRUCTION LIGHT
35	GI PIPE	GALVANIZED IRON PIPE

REV	DATE	DESCRIPTION	CAD	DGN	SL	CKD	PDP
01	08-01-25	REVISED					
0	17-10-24	FIRST ISSUE					
REVISIONS							
EMPLOYER:							
NATIONAL TRANSMISSION & DESPATCH COMPANY LIMITED							
CONSULTANT:							
CONTRACTOR:							
SUBCONTRACTOR:							
HUAWEI TECHNOLOGIES CO.LTD. HUAWEI							
PROJECT:							
ADB-202R-2019:PROCUREMENT OF PLANT, DESIGN, SUPPLY, INSTALLATION, TESTING, AND COMMISSIONING OF SCADA PHASE-3 AND REVENUE METERING SYSTEM (RMS) NTDC LOAN NO.3577-PAK; SECOND POWER TRANSMISSION INVESTMENT PROGRAM, TRANCHE-2							
DRAWING TITLE:							
MICROWAVE STATION 120M GUYED MAST TOWER LIST OF DRAWING							
SCALE: AS SHOWN							
SITE ADDRESS:							
220 KV GRID STATION ISLAMABAD PESHAWAR ROAD (SANGJANI)							
SITE I.D							
ISPR 220KV							
SCALE	DRAWN	DESIGNED	CHECKED	APPROVED	DATE		
AS SHOWN	MJK	S. ARSALAN	SHOAB	F.AJ KHARRI	17-10-24		
JOB NO.		DRAWING NO.		REV.			
---		LDP-III-A-SR116-DWG-LIST		01			

GENERAL NOTES:

A. GENERAL

- These Notes should be read in conjunction with relevant Contract conditions, Technical specifications and Bill of Quantities for the Project. Wherever more than one set of standards is used to specify Material, Test or level of workmanship, the most stringent requirements shall govern unless especially otherwise noted.
- All Materials used and workmanship involved in the execution of all work covered under this contract shall be in strict conformity with Drawings, Specifications & Contract conditions.
- Where Reference standards for testing Materials and Workmanship are not explicitly-stated on the Drawings and Contract documents, latest relevant standards of AASHTO, ASTM or BS shall be applicable as required by the engineer.
- Excavated material to be dumped away from the site and must not be used in backfilling.
- Backfilling if required shall be done on well-graded and mixture of non-toxic soils. Approved fill material shall be placed in layers not exceeding 150mm in compacted thickness. Backfill shall be compacted to a dry density not a less than 95% of maximum dry density as determined by modified proctor compaction test (ASTMD-1557) for materials being compacted unless otherwise noted.
- Anti-vegetation measures must be followed such that top 150mm layer fill at site to be mixed with 5% lime or caustic soda.
- Floor Finish Specifications:
-SILTY SNAD/GHASSU:
-AASHTO CLASSIFICATION = A-2-4(0)
-PASSING SIEVE NO. = FROM 10% TO 20%
-SILT = 10% TO 20%
-SAND = 80% TO 90%
-GRAVEL:
-CRUSHED AGGREGATE
-MAX SIZE 25MM
-MIN SIZE 19MM
- Anti termite proofing under floors and foundations including plinth protection shall be done for new microwave hut building sites.
- All the concrete surfaces in contact with soil shall be coated with two coats of hot bitumen (0.6kg/m²)

B. SETTING OUT AND LEVELS

- All Dimensions indicated on the drawing are in millimeters. All Elevations and levels are in meters.
- All structure drawings shall be read in conjunction with the Architectural, Mechanical and Electrical Engineering drawings.
- The contractor shall verify all dimension and levels on site and resolve all discrepancies with the Engineer before commencement of works.
- Prior approval of all layout dimensions shall be taken from the engineer incharge before execution of work.

C. MATERIAL

UNLESS SPECIFIED OTHERWISE MATERIAL SHALL CONFORM TO THE FOLLOWING STANDARDS. :-

MASONRY WORKS

- M1 Average compressive strength of first class brick shall be minimum 1500 Psi. Compressive strength of load bearing blocks, non-bearing blocks and Fill in Block are 12 MPa, 10 MPa and 5 MPa respectively which shall not be less than the specified strengths.
- M2 Brick Masonry with 1:4 C/S mortar in super-structure and 1:3 in sub-structure shall be provided
- M3 All Masonry units shall be normal weight concrete unless noted otherwise.
- M4 Remove old paint & plaster before apply new plaster & paint. For plaster, use cement and sand mortar. Make sure to provide the plaster on walls and roof as per specified thickness in DED.
- M5 Plaster of C/S 1:3 shall be applied on all masonry walls internally and externally . All masonry walls shall be plastered in the substructure internally and externally above FGL. Whereas the concrete structure elements in the superstructure (Columns, Beams and walls) adjacent to masonry walls (flushed with walls) shall be plastered after roughening the surface.

REINFORCED CONCRETE







- C1a Cement type will be selected / preferred as per exposure class of ACI-318.
- C1b Minimum cement content used in mix design is 350kg/m³ as per NTDC specification.
- C2a Lean, Leveling, Blinding concrete shall have an average minimum cylindrical strength of 140 kg/ cm² at 28 days confirming to approved mix design.
- C2b All structural concrete (Plant/Mechanically mixed) shall have an average minimum cylindrical strength of 210 Kg/cm² (3000 Psi) at 28 days.
- C3 Water Cement Ratio shall not exceed 0.45 for underground and water structure & 0.5 for all other structure.
- C4 Maximum possible water-soluble chloride ion (cl) content shall not exceed 0.15% by weight of cement.
- C5 Aggregate size shall be according to approved mix design as per referred maximum aggregate size. Aggregate (fine & coarse) gradation shall be according to ASTM C-33 whereas aggregate shall confirmed to standard specification of concrete aggregate ASTM C-33.
- C6 Civil Contractor shall get approval from design consultant of a concrete mix design.
- C7 The Civil Contractor shall perform and submit for review instrument surveys of finished concrete slab surfaces, both before and after removal of form work and/or shoring system to verify As-Built Tolerances.
- C8 All Concrete shall contain and approved water reducing, Plasticizing Admixture approved high range water reducing admixture may be utilized at the contractor's option. All concrete permanently exposed to weather shall also contain an approved air-entraining admixture to provide percentage of air required for severe exposure as per ACI 318 and Design Mix Criteria.
- C9 Admixture/Water Containing chloride ions shall not be used in any concrete.
- C10 Slump shall be as per approved mix design.
- C11 Blinding concrete must be placed on undisturbed firm soil.


REINFORCEMENT

- R1 All steel reinforcement Grade-60 (Deformed/Ribbed Bar) shall have minimum yield strength of 414 MPA (60,000 Psi) and shall confirm to all the requirements of ASTM A-615.
- R2 All Reinforcement bars shall be detailed, fabricated, labeled, supported, spaced in forms and secured in place in accordance with the procedures and requirements outlined in the current ACI 318 and ACI 315 unless noted otherwise on the structural drawings.

ABBREVIATIONS :

E.R.L.	EXISTING ROAD LEVEL
P.L.	PLINTH LEVEL
MAX.	MAXIMUM
AVG.	AVERAGE
MIN.	MINIMUM
S.L.	STRUCTURAL LEVEL
DED	DETAILED ENGINEERING DRAWING

REV	DATE	DESCRIPTION	CAD	DGN	SL	CHK	APPD
0	17-10-24	FIRST ISSUE					
REVISIONS							
EMPLOYER:  NATIONAL TRANSMISSION & DESPATCH COMPANY LIMITED							
CONSULTANT:  SAGE Automation 							
CONTRACTOR:  CMEC  Hitachi Energy							
SUBCONTRACTOR:  HUAWEI TECHNOLOGIES CO.LTD.							
PROJECT: ADB-202R-2019/PROCUREMENT OF PLANT, DESIGN, SUPPLY, INSTALLATION, TESTING, AND COMMISSIONING OF SCADA PHASE-3 AND REVENUE METERING SYSTEM (RMS) NTDC LOAN NO.3577-PAK: SECOND POWER TRANSMISSION INVESTMENT PROGRAM, TRANCHE-2							
DRAWING TITLE: MICROWAVE STATION 120M GUYED MAST TOWER GENERAL NOTES							
SCALE: AS SHOWN							
SITE ADDRESS: 220 KV GRID STATION ISLAMABAD PESHAWAR ROAD (SANGJANI)							
SITE I.D ISPR 220KV							
SCALE	DRAWN	DESIGNED	CHECKED	APPROVED	DATE		
AS SHOWN	M.K	S.ARSALAN	SHOAB	F.A.KHARRI	17-10-24		
JOB NO.		DRAWING NO.		REV.			
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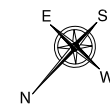


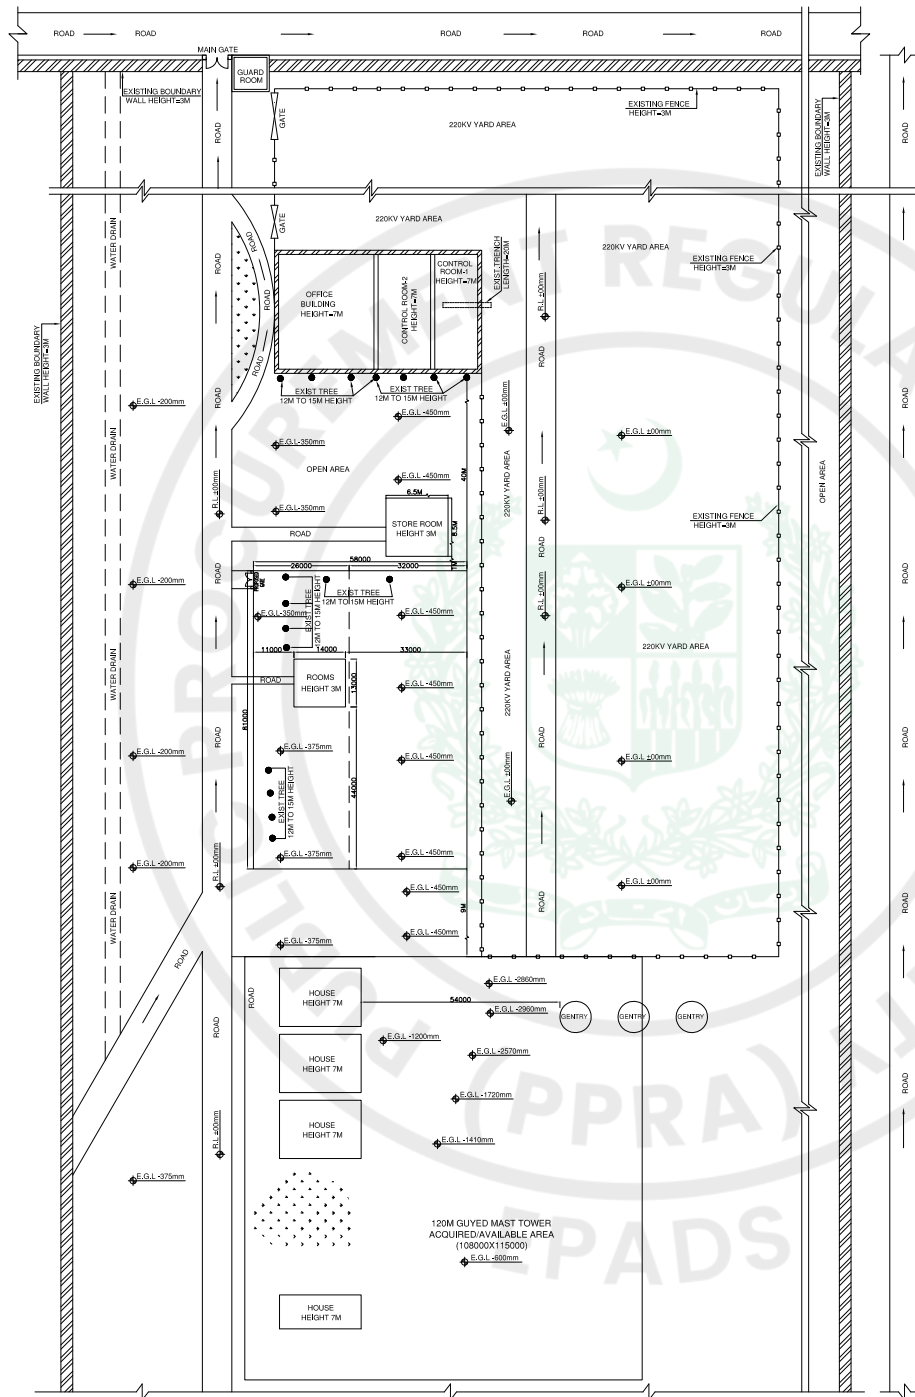MICROWAVE STATION
EXISTING SITE LOCATION PLAN

NOTE:

- E.G.L OF THE PLOT IS 1200mm DOWN FROM THE ROAD LEVEL.
- THE CLEARING AND GRUBBING OF PLOT REQUIRED TO ACHIEVE SAME PLOT LEVELS.
- ALL DIMENSIONS ARE IN MM UNLESS OTHERWISE SPECIFIED.

LEGENDS	
R.L	ROAD LEVEL
E.G.L	EXISTING GROUND LEVEL



COORDINATE OF SITE	
LONGITUDE	72°50'15.00" E
LATITUDE	33°40'34.14" N

REV	DATE	DESCRIPTION	CAD	DN	SL	CRD	APD
02	08-01-25	REVISED					
01	13-12-24	REVISED					
-	17-10-24	FIRST ISSUE					

REVISIONS

EMPLOYER:



CONSULTANT:



CONTRACTOR:



SUBCONTRACTOR:



PROJECT:
ADB-202R-2019: PROCUREMENT OF PLANT, DESIGN, SUPPLY, INSTALLATION, TESTING, AND COMMISSIONING OF SCADA PHASE-3 AND REVENUE METERING SYSTEM (RMS) NTDC L OAN NO.3577-PAK: SECOND POWER TRANSMISSION INVESTMENT PROGRAM, TRANCHE-2


DRAWING TITLE:
MICROWAVE STATION
120M GUYED MAST TOWER
EXISTING SITE LOCATION PLAN

SCALE: NTS

SITE ADDRESS:
220 KV GRID STATION ISLAMABAD PESHAWAR ROAD (SANGJANI)

SITE I.D
ISPR 220KV

SCALE	DRAWN	DESIGNED	CHECKED	APPROVED	DATE
AS SHOWN	MJC	SAJD	KAMRANZ	F.A.KHARRI	17-10-24
JOB NO.	DRAWING NO.		REV.		
--	LDP-III-A-SR116-DWG-001		02		

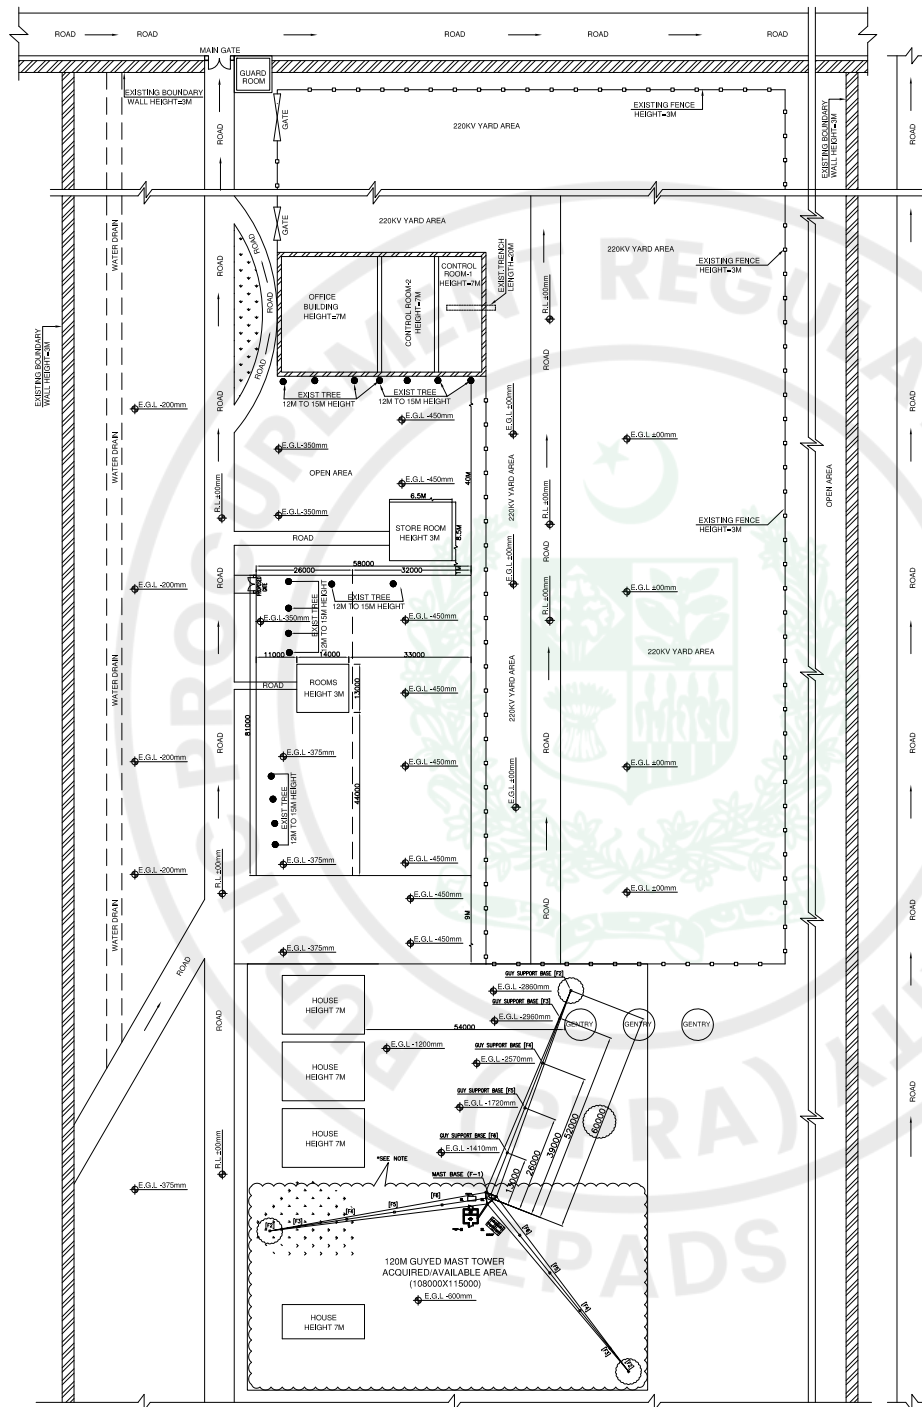

**MICROWAVE STATION
PROPOSED SITE LOCATION PLAN**

- NOTE:**
- E.G.L OF THE PLOT IS 1200mm DOWN FROM THE ROAD LEVEL.
 - THE CLEARING AND GRUBBING OF PLOT REQUIRED TO ACHIEVE SAME PLOT LEVELS.
 - ALL DIMENSIONS ARE IN MM UNLESS OTHERWISE SPECIFIED.
 - * THE GROUND LEVEL OF THE MAIN GUY MAST & THE GUYED WIRES SUPPORTS IN THIS AREA TO BE MAINTAINED AT-600MM.

LEGENDS

R.L	ROAD LEVEL
E.G.L	EXISTING GROUND LEVEL

COORDINATE OF SITE

LONGITUDE	72°50'15.00" E
LATITUDE	33°40'34.14" N

REV	DATE	DESCRIPTION	CAD	DN	SL	CHK	APPD
03	08-01-25	REVISED					
02	13-12-24	REVISED					
01	09-12-24	REVISED AS PER CLOUD					
-	17-10-24	FIRST ISSUE					

REVISIONS

EMPLOYER:
NATIONAL TRANSMISSION & DESPATCH COMPANY LIMITED

CONSULTANT:
SAGE Automation

CONTRACTOR:
CMEC
Hitachi Energy

SUBCONTRACTOR:
HUAWEI TECHNOLOGIES CO.LTD.

PROJECT:
 ADB-202R-2019: PROCUREMENT OF PLANT, DESIGN, SUPPLY, INSTALLATION, TESTING, AND COMMISSIONING OF SCADA PHASE-3 AND REVENUE METERING SYSTEM (RMS) INTDC L OAN NO.3577-PAK: SECOND POWER TRANSMISSION INVESTMENT PROGRAM, TRANCHE-2



DRAWING TITLE:
 MICROWAVE STATION
 120M GUYED MAST TOWER
 PROPOSED SITE LOCATION PLAN

SCALE: NTS

SITE ADDRESS:
 220 KV GRID STATION ISLAMABAD PESHAWAR ROAD (SANGJANI)

SITE I.D
 ISPR 220KV

SCALE	DRAWN	DESIGNED	CHECKED	APPROVED	DATE
AS SHOWN	MJK	SAJD	KAMRANZ	F.A.KHARRI	17-10-24
	JOB NO.		DRAWING NO.		REV.
			LDP-III-A-SR116-DWG-0002		03

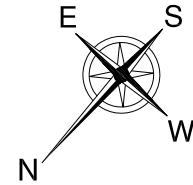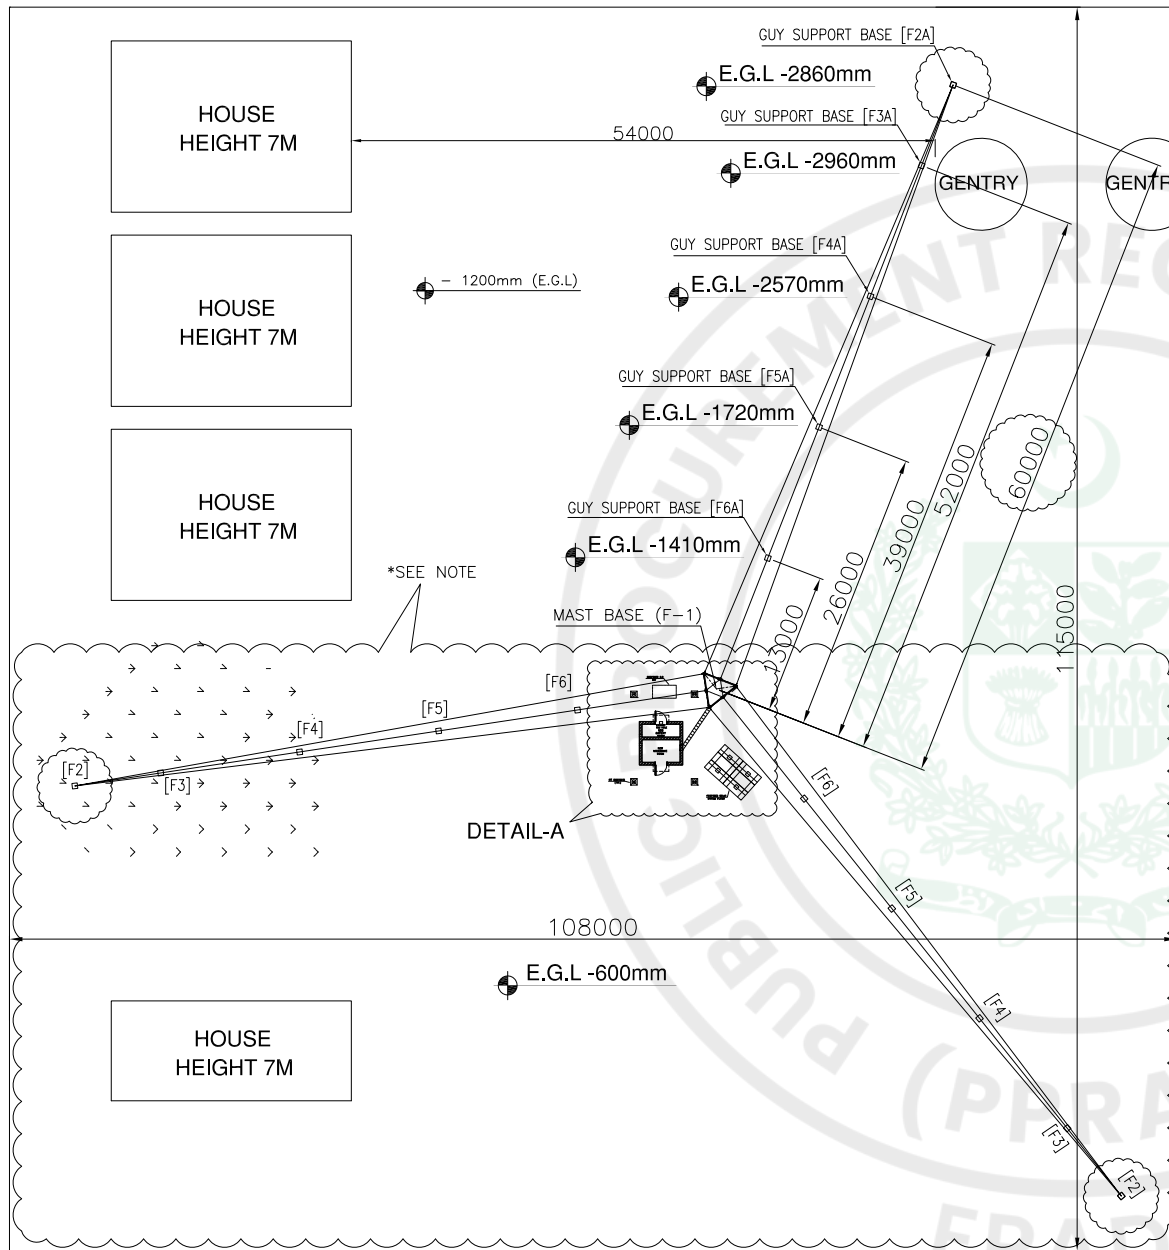


COORDINATE OF SITE	
LONGITUDE	72°50'15.00" E
LATITUDE	33°40'34.14" N

NOTE:
 * THE GROUND LEVEL OF THE MAIN GUY MAST & THE GUYED WIRES SUPPORTS IN THIS AREA TO BE MAINTAINED AT -600MM.

LEGEND		
S.NO	SYMBOL	DESCRIPTION
1		EARTHING PIT FOR BTS
2		EARTHING PIT FOR TOWER
3		EARTHING PIT FOR SOLAR
4		EARTHING PIT FOR DG







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01	09-12-24	REVISED AS PER CLOUD					
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REVISIONS							
EMPLOYER:							
NATIONAL TRANSMISSION & DESPATCH COMPANY LIMITED							
CONSULTANT:							
CONTRACTOR:							
SUBCONTRACTOR:							
HUAWEI TECHNOLOGIES CO.LTD.							
PROJECT: ADB-202R-2019: PROCUREMENT OF PLANT, DESIGN, SUPPLY, INSTALLATION, TESTING, AND COMMISSIONING OF SCADA PHASE-3 AND REVENUE METERING SYSTEM (RMS) NTDCL OAN NO.3577-PAK: SECOND POWER TRANSMISSION INVESTMENT PROGRAM, TRANCHE-2							
DRAWING TITLE: MICROWAVE STATION 120M GUYED MAST TOWER PROPOSED SITE LAYOUT PLAN							
SCALE: NTS							
SITE ADDRESS: 220 KV GRID STATION ISLAMABAD PESHAWAR ROAD (SANGJANI)							
SITE I.D							
ISPR 220KV							
SCALE AS SHOWN	DRAWN MJC	DESIGNED SAJD	CHECKED KAMRANZ	APPROVED F.A.KHARRI	DATE 17-10-24		
JOB NO.		DRAWING NO.		REV.			
		LDP-III-A-SR116-DWG-0003		03			

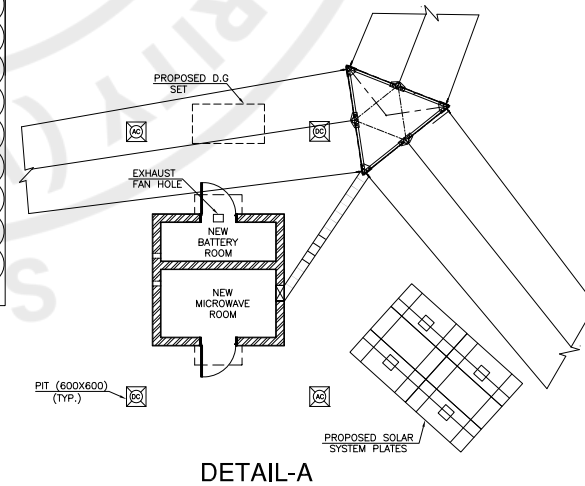

MICROWAVE STATION PROPOSED SITE LAYOUT PLAN

DETAIL-A

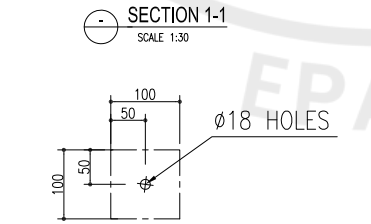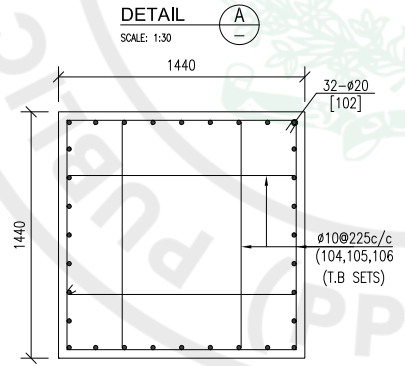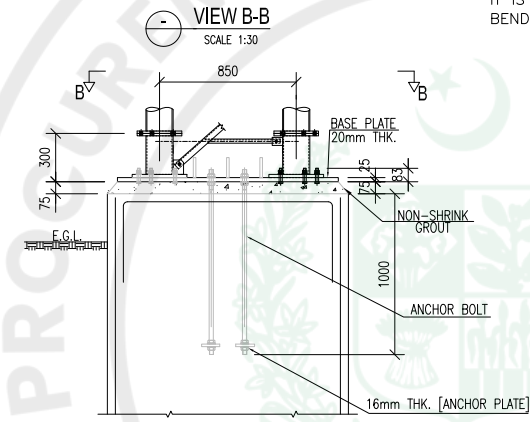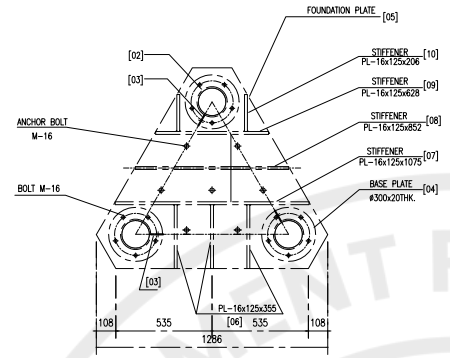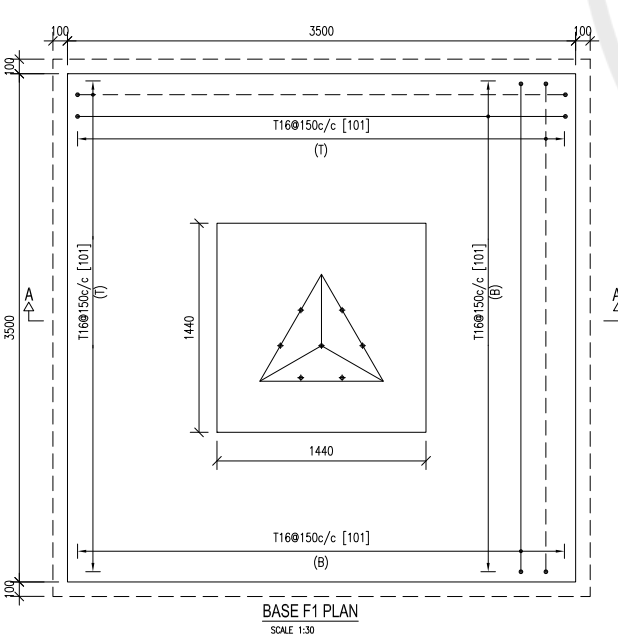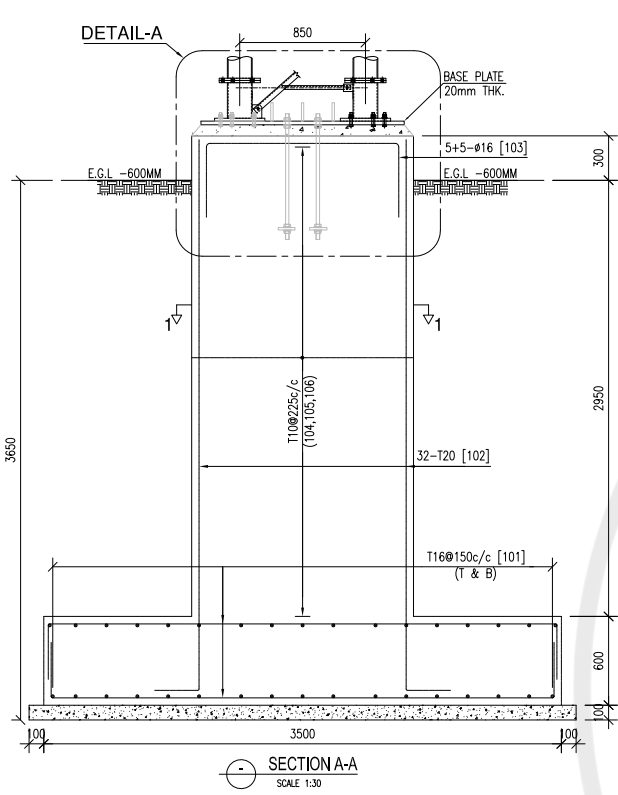


PL. 16x100x100 [11] 7NOS.

SCHEDULE OF BAR BENDING							
BAR NOTATION	SHAPE	BAR Ø	SPACING	CUT LENGTH	QTY	WEIGHT (kg/m)	WEIGHT (kg)
101		16	150	3950	24x4=96	1.58	599
102		20	--	4025	32	2.46	317
103		16	--	2300	5+5=10	1.58	36
104		10	225	5600	15	0.62	52
105		10	225	4820	15	0.62	45
106		10	225	4310	15	0.62	40
TOTAL =							1089 Kg.

NOTE:
IT IS THE RESPONSIBILITY OF CONTRACTOR TO CHECK THE BENDING SCHEDULE ACCORDING TO DIMENSIONS AT SITE.

QUANTITIES FOR FOUNDATION ARE AS FOLLOWS.

NOS.	DESCRIPTION	UNIT	QUANTITIES
1	EXCAVATION	CU.M	50
2	BACK FILLING	CU.M	35.20
3	CONCRETE 1:1.5:3	CU.M	14.10
	1:4-8 CONCRETE	CU.M	1.37

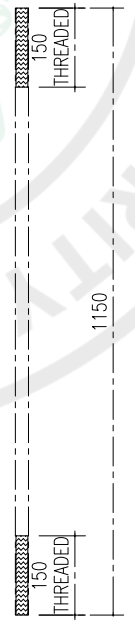

ANCHOR BOLT DETAIL (7 NOS.) [12]
M16x1150 STD.WITHWORTH THREADS

- NOTES:
- ALL DIMENSIONS ARE IN MM UNLESS NOTED OTHERWISE. ALL DIMENSIONS SHOWN ON THE DRAWING SHALL BE CONFIRMED PRIOR TO START OF CONSTRUCTION WORK.
 - THE DRAWING SHALL BE READ IN CONJUNCTION WITH GUY MAST DRAWINGS.
 - ALL WORK AND MATERIAL SHALL CONFORM TO THE PROJECTS SPECIFICATIONS AND MINIMUM STANDARDS OF THE UBC 97 / ACI.
 - FOUNDATION IS DESIGNED FROM A NET BEARING CAPACITY OF 1.5 TSF AT 3.65 M DEPTH WHICH SHALL BE CONFIRMED AT THE TIME OF CONSTRUCTION.
 - ALL CONCRETE (1:1-1/2:3) CYLINDER STRENGTH SHALL BE MINIMUM 21 N/mm² (3000 PSI).
 - CURING COMPOUND SHALL BE USED FOR CURING OF CONCRETE.
 - MATERIAL: UNLESS SPECIFIED OTHERWISE MATERIAL SHALL CONFORM TO THE FOLLOWING STANDARD.
 - a. REINFORCED CEMENT CONCRETE:
 - CEMENT = BS12/BS 4246
 - COARSE/FINE AGGREGATE = BS 882
 - NOMINAL MIX AGGREGATE = 20mm
 - WHEN TESTING IN ACCORDANCE WITH BS 4550, ORDINARY PORTLAND CEMENT AS WELL AS HIGH SLAG PORTLAND BLAST FURNACE CEMENT SHALL MEET THE FOLLOWING SPECIFIC REQUIREMENT NTS:
 - C₄A = 5% TO 8%
 - C₄AF = +2% A < 20%
 - A₁ C₃ < 8%
 - MAX. WATER CEMENT RATIO FOR ALL STRUCTURE SHALL NOT EXCEED 0.4
 - REINFORCEMENT:
 - ALL REINFORCEMENT STEEL SHALL BE MINIMUM YIELD STRENGTH 415 N/mm² (60000 PSI).
 - CLEAR COVER REINFORCEMENT
 - a. FOUNDATION = 75mm
 - b. COLUMN = 50mm
 - IN NO CASE FOUNDATION SHALL REST ON FILLED SOIL.
 - WELL GRADED SAND GRAVEL MIXER SHALL BE USED FOR BACKFILLING PURPOSE.
 - CLAYEY SOIL SHALL NOT BE USED FOR BACKFILLING IN ANY CASE.
 - ACCUMULATION OF WATER ON BACKFILL AREAS SHALL BE AVOIDED.
 - BACKFILLING & COMPACTION SHALL BE IN SUCCESSIVE LAYERS OF NOT MORE THAN 150mm AS PER SOIL REPORT.
 - DRY DENSITY OF THE BACKFILL ACHIEVED AFTER COMPACTION SHALL NOT BE LESS THAN 95% OF MODIFIED AASHTO DRY DENSITY.
 - ALL EXCAVATED AREAS SHALL BE KEPT DRY DURING FOUNDATION WORK.
 - ALL STRUCTURAL CONCRETE SURFACES AGAINST WHICH EARTH IS TO BE FILLED SHALL BE COATED WITH TWO COATS OF SPECIAL INDUSTRIAL BITUMEN (10/20 GRADE) APPLIED HOT AT THE RATE OF 1.0 KG/SQM PER COAT.
 - FOR SETTING TEMPLATES, BASE PLATE AND ANCHOR BOLTS REFER GUY MAST DRAWINGS.
 - PRIOR TO PROVIDING FOUNDATION CONCRETE, THE FOUNDATION SOIL AFTER EXCAVATION SHALL BE THOROUGHLY COMPACTED FOR BETTER STABILITY.
 - ALL LAPS ARE 54# UNLESS OTHERWISE NOTED

REV	DATE	DESCRIPTION	CAD	DGR	SL	CHD	APD
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01	13-12-24	REVISED					
0	17-10-24	FIRST ISSUE					

REVISIONS

EMPLOYER:

CONSULTANT:

CONTRACTOR:

SUBCONTRACTOR:

PROJECT:
ADB-202R-2019: PROCUREMENT OF PLANT, DESIGN, SUPPLY, INSTALLATION, TESTING, AND COMMISSIONING OF SCADA PHASE-3 AND REVENUE METERING SYSTEM (RMS)
NTDC LOAN NO.3577-PAK: SECOND POWER TRANSMISSION INVESTMENT PROGRAM, TRANCHE-2

DRAWING TITLE:
MICROWAVE STATION
120M GUYED MAST TOWER
TOWER BASE FOUNDATION DETAILS






SCALE: AS SHOWN

SITE ADDRESS:
220 KV GRID STATION ISLAMABAD PESHAWAR ROAD (SANGJANI)

SITE I.D.
ISPR 220KV

SCALE	DRAWN	DESIGNED	CHECKED	APPROVED	DATE
AS SHOWN	MK	SA	MT	RS	17-10-24

ISS NO. LDP-IL-ESK-16-010-004

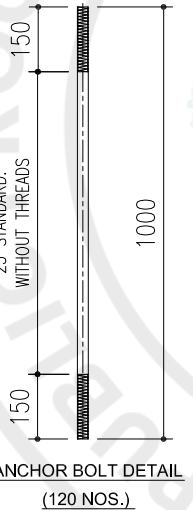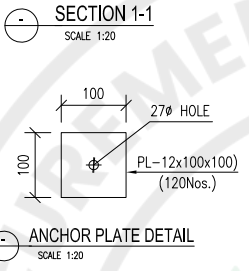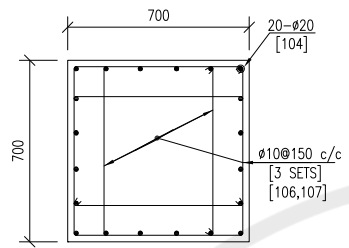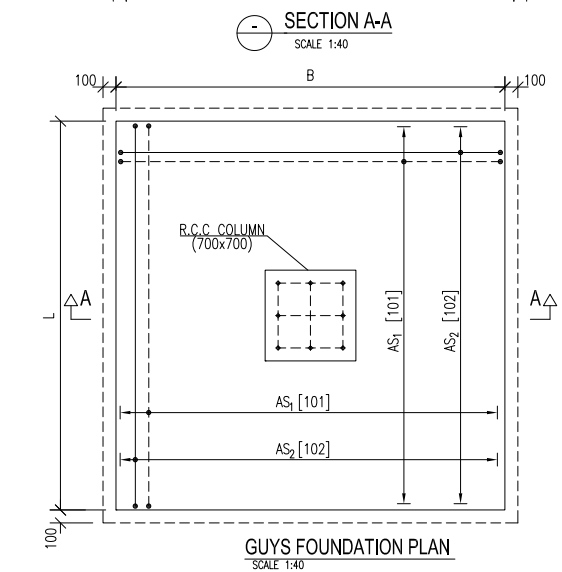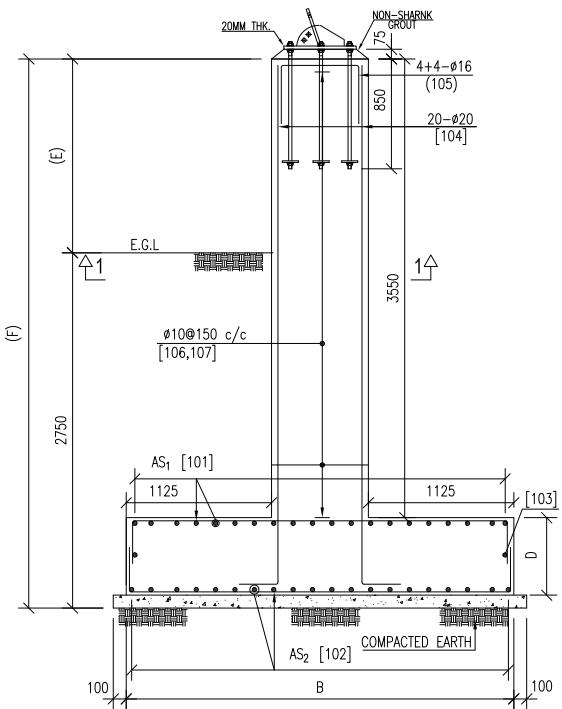

SCHEDULE OF R.C.C.FOOTINGS

FOOTINGS MARK	SIZES (LxB)	DEPTH D	E	F	REINFORCEMENT	
					AS1	AS2
F-2	2950x2950	600	300	3050	ø16@150 c/c	ø16@150 c/c
F-2A	3400x3400	600	2560	5310	ø16@150 c/c	ø16@150 c/c
F-3	2850x2850	600	300	3050	ø16@150 c/c	ø16@150 c/c
F-3A	3300x3300	600	2660	5410	ø16@150 c/c	ø16@150 c/c
F-4	2800x2800	600	300	3050	ø16@150 c/c	ø16@150 c/c
F-4A	3100x3100	600	2270	5520	ø16@150 c/c	ø16@150 c/c
F-5	2750x2750	600	300	3050	ø16@150 c/c	ø16@150 c/c
F-5A	2900x2900	600	1420	4170	ø16@150 c/c	ø16@150 c/c
F-6	2700x2700	600	300	3050	ø16@150 c/c	ø16@150 c/c
F-6A	2800x2800	600	1100	3860	ø16@150 c/c	ø16@150 c/c

F2 TO F6 COLUMN / PEDESTAL

MARK	SIZE	DEPTH	E	F	REINFORCEMENT	WEIGHT
104	300x300	20	--	3125	20x10=200	1538
105	450x450	16	--	1460	(4+4)10=80	185
106	600x600	10	150	2640	17x10=170	278
107	600x600	10	150	2260	(17x2)10=340	476

NOTE:
IT IS THE RESPONSIBILITY OF CONTRACTOR TO CHECK THE BENDING ALL SCHEDULE ACCORDING TO DIMENSIONS AT SITE.

TOTAL = 2477 Kg.

F2A COLUMN / PEDESTAL

MARK	SIZE	DEPTH	E	F	REINFORCEMENT	WEIGHT
104	300x300	20	--	5385	20	265
105	450x450	16	--	1460	(4+4)=8	18
106	600x600	10	150	2640	32	52
107	600x600	10	150	2260	(32x2)=64	90

TOTAL = 425 Kg.

QUANTITIES FOR FOUNDATION ARE AS FOLLOWS.

NOS.	DESCRIPTION	UNIT	F2	F3	F4	F5	F6	F2A	F3A	F4A	F5A	F6A
1	EXCAVATION	CU.M	27.29x2=54.57	25.58x2=51.16	24.75x2=49.5	23.9x2=47.8	23.13x2=46.26	35.64	33.7	30.00	26.43	24.75
2	BACK FILLING	CU.M	20.1x2=40.20	18.78x2=37.56	18.14x2=36.28	16.81x2=33.62	16.91x2=33.82	26.4	24.94	22.14	19.43	18.15
3	CONCRETE 1:1.5:3	CU.M	6.4x2=12.8	6.1x2=12.2	5.86x2=11.72	5.7x2=11.40	5.53x2=11.10	9.19	8.84	7.90	6.74	6.25
4	1:4:8 CONCRETE	CU.M	1x2=2.0	0.93x2=1.86	0.90x2=1.8	0.87x2=1.74	0.84x2=1.68	1.30	1.23	1.10	0.96	0.90

- NOTES:**
- ALL DIMENSIONS ARE IN MM UNLESS NOTED OTHERWISE. ALL DIMENSIONS SHOWN ON THE DRAWING SHALL BE CONFIRMED PRIOR TO START OF CONSTRUCTION WORK.
 - THE DRAWING SHALL BE READ IN CONJUNCTION WITH GUY MAST DRAWINGS.
 - ALL WORK AND MATERIAL SHALL CONFORM TO THE PROJECTS SPECIFICATIONS AND MINIMUM STANDARDS OF THE UBC 97 / ACI.
 - FOUNDATION IS DESIGNED FROM A NET BEARING CAPACITY OF 1.2 TSF AT 2.75 M DEPTH WHICH SHALL BE CONFIRMED AT THE TIME OF CONSTRUCTION.
 - ALL CONCRETE (1-1-1/2-3) CYLINDER STRENGTH SHALL BE MINIMUM 21 N/mm² (3000 PSI).
 - CURING COMPOUND SHALL BE USED FOR CURING OF CONCRETE.
 - MATERIAL:**
UNLESS SPECIFIED OTHERWISE MATERIAL SHALL CONFORM TO THE FOLLOWING STANDARD.
 - a. **REINFORCED CEMENT CONCRETE:**
CEMENT = BS12/BS 4246
COARSE/FINE AGGREGATE = BS 882
NOMINAL MIX AGGREGATE = 20mm
WHEN TESTING IN ACCORDANCE WITH BS 4550, ORDINARY PORTLAND CEMENT AS WELL AS HIGH SLAG PORTLAND BLAST FURNACE CEMENT SHALL MEET THE FOLLOWING SPECIFIC REQUIREMENT NITS.
 - C₄ = 5% TO 8%
 - C₂A₁F = +2C₂A < 20%
 - A₁O₁ < 8%
 - MAX. WATER CEMENT RATIO FOR ALL STRUCTURE SHALL NOT EXCEED 0.4
 - d. **REINFORCEMENT:**
- ALL REINFORCEMENT STEEL SHALL BE MINIMUM YIELD STRENGTH 415 N/mm² (60000 PSI).
 - 8. CLEAR COVER REINFORCEMENT**
 - a. FOUNDATION = 75mm
 - b. COLUMN = 50mm
 9. IN NO CASE FOUNDATION SHALL REST ON FILLED SOIL.
 10. WELL GRADED SAND GRAVEL MIXER SHALL BE USED FOR BACKFILLING PURPOSE.
 11. CLAYEY SOIL SHALL NOT BE USED FOR BACKFILLING IN ANY CASE.
 12. ACCUMULATION OF WATER ON BACKFILL AREAS SHALL BE AVOIDED.
 13. BACKFILLING & COMPACTION SHALL BE IN SUCCESSIVE LAYERS OF NOT MORE THAN 150mm AS PER SOIL REPORT.
 14. DRY DENSITY OF THE BACKFILL ACHIEVED AFTER COMPACTION SHALL NOT BE LESS THAN 95% OF MODIFIED AASHTO DRY DENSITY.
 15. ALL EXCAVATED AREAS SHALL BE KEPT DRY DURING FOUNDATION WORK.
 16. ALL STRUCTURAL CONCRETE SURFACES AGAINST WHICH EARTH IS TO BE FILLED SHALL BE COATED WITH TWO COATS OF SPECIAL INDUSTRIAL BITUMEN (10/20 GRADE) APPLIED HOT AT THE RATE OF 1.0 KG/50M PER COAT.
 17. FOR SETTING TEMPLATES, BASE PLATE AND ANCHOR BOLTS REFER GUY MAST DRAWINGS.
 18. PRIOR TO PROVIDING FOUNDATION CONCRETE, THE FOUNDATION SOIL AFTER EXCAVATION SHALL BE THOROUGHLY COMPACTED FOR BETTER STABILITY.
 19. ALL LAPS ARE 544 UNLESS OTHERWISE NOTED.

REV	DATE	DESCRIPTION	CAD	DGN	SL	CHK	APP
02	08-01-25	REVISED					
01	13-12-24	REVISED					
0	17-10-24	FIRST ISSUE					

REVISIONS

EMPLOYER:
 NATIONAL TRANSMISSION & DESPATCH COMPANY LIMITED

CONSULTANT:
 SAGE Automation

CONTRACTOR:
 CMEC
 Hitachi Energy

SUBCONTRACTOR:
 HUAWEI TECHNOLOGIES CO.LTD.

PROJECT:
 ADB-2029-2019: PROCUREMENT OF PLANT, DESIGN, SUPPLY, INSTALLATION, TESTING AND COMMISSIONING OF SCADA PHASE-3 AND REVENUE METERING SYSTEM (RMS)
 NTDC LOAN NO.3577-PAK: SECOND POWER TRANSMISSION INVESTMENT PROGRAM, TRANCHE-2

DRAWING TITLE:
 MICROWAVE STATION
 120M GUYED MAST TOWER
 GUYS BASE FOUNDATION DETAIL

SCALE: AS SHOWN

SITE ADDRESS:
 220 KV GRID STATION ISLAMABAD PESHAWAR ROAD (SANGJANI)

SITE I.D.

ISPR 220KV						
SCALE	DRAWN	DESIGNED	CHECKED	APPROVED	DATE	
AS SHOWN	ISMAIL	SA	MT	RS	17-10-24	
ISS NO.	DRAWING NO. 4-103					REV.
	LDP-11-2019-15-CYC-000A					02

SCHEDULE OF BAR BENDING							
BAR NOTATION	SHAPE	BAR Ø	SPACING	CUT LENGTH	QTY	WEIGHT (kg/m)	WEIGHT (kg)
F2 (2Nos.)							
101		16	150	3400	(21x2)=84	1.58	451
102		16	150	3400	(21x2)=84	1.58	451
103		16	--	6400	(1+1)=4	1.58	40
F2A (1Nos.)							
101		16	150	3850	(24x2)=48	1.58	292
102		16	150	3850	(24x2)=48	1.58	292
103		16	--	7300	(1+1)=2	1.58	23
F3 (2Nos.)							
101		16	150	3300	(20x2)=80	1.58	417
102		16	150	3300	(20x2)=80	1.58	417
103		16	--	6200	(1+1)=2	1.58	39
F3A (1Nos.)							
101		16	150	3750	(23x2)=46	1.58	273
102		16	150	3750	(23x2)=46	1.58	273
103		16	--	7100	(1+1)=2	1.58	22
F4 (2Nos.)							
101		16	150	3250	(19x2)=76	1.58	390
102		16	150	3250	(19x2)=76	1.58	390
103		16	--	6100	(1+1)=2	1.58	39
F4A (1Nos.)							
101		16	150	3550	(22x2)=44	1.58	247
102		16	150	3550	(22x2)=44	1.58	247
103		16	--	6700	(1+1)=2	1.58	21
F5 (2Nos.)							
101		16	150	3200	(19x2)=76	1.58	384
102		16	150	3200	(19x2)=76	1.58	384
103		16	--	6000	(1+1)=2	1.58	38
F5A (1Nos.)							
101		16	150	3350	(21x2)=84	1.58	445
102		16	150	3350	(21x2)=84	1.58	445
103		16	--	6300	(1+1)=2	1.58	40
F6 (2Nos.)							
101		16	150	3150	(18x2)=72	1.58	358
102		16	150	3150	(18x2)=72	1.58	358
103		16	--	5900	(1+1)=2	1.58	37
F6A (1Nos.)							
101		16	150	3250	(19x2)=76	1.58	390
102		16	150	3250	(19x2)=76	1.58	390
103		16	--	6100	(1+1)=2	1.58	39
						TOTAL =	7632 Kg.

F3A							
COLUMN / PEDESTAL							
104		20	--	5485	20	2.46	270
105		16	--	1460	(4+4)=8	1.58	18
106		10	150	2640	32	0.62	52
107		10	150	2260	(32x2)=64	0.62	90
						TOTAL =	430 Kg.

F4A							
COLUMN / PEDESTAL							
104		20	--	5595	20	2.46	275
105		16	--	1460	(4+4)=8	1.58	18
106		10	150	2640	33	0.62	54
107		10	150	2260	(33x2)=66	0.62	92
						TOTAL =	439 Kg.

F5A							
COLUMN / PEDESTAL							
104		20	--	4245	20	2.46	209
105		16	--	1460	(4+4)=8	1.58	18
106		10	150	2640	24	0.62	39
107		10	150	2260	(24x2)=48	0.62	67
						TOTAL =	333 Kg.

F6A							
COLUMN / PEDESTAL							
104		20	--	3935	20	2.46	194
105		16	--	1460	(4+4)=8	1.58	18
106		10	150	2640	22	0.62	36
107		10	150	2260	(22x2)=44	0.62	62
						TOTAL =	310 Kg.

REV	DATE	DESCRIPTION	CAD	DGN	SL	CHK	APP
0	06-01-25	FIRST ISSUE					

REVISIONS

EMPLOYER:
NATIONAL TRANSMISSION & DESPATCH COMPANY LIMITED

CONSULTANT:
SAGE Automation

CONTRACTOR:
CMCC
Hitachi Energy

SUBCONTRACTOR:
HUAWEI TECHNOLOGIES CO.LTD.

PROJECT:
 ADB-202R-2019: PROCUREMENT OF PLANT, DESIGN, SUPPLY, INSTALLATION, TESTING AND COMMISSIONING OF SCADA PHASE-3 AND REVENUE METERING SYSTEM (RMS) NTDC LOAN NO.3577-PAK: SECOND POWER TRANSMISSION INVESTMENT PROGRAM, TRANCHE-2

DRAWING TITLE:
MICROWAVE STATION 120M GUYED MAST TOWER GUY'S BASE FOUNDATION DETAIL LIST


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SITE ADDRESS:
 220 KV GRID STATION ISLAMABAD PESHAWAR ROAD (SANGJANI)


SITE I.D.
ISPR 220KV

SCALE	DRAWN	DESIGNED	CHECKED	APPROVED	DATE
AS SHOWN	ISMAIL	SA	MT	RS	17-10-24


JOB NO. _____ DRAWING NO. **4103** REV. _____
 LDP-11-2511E-2102-01A-B 00

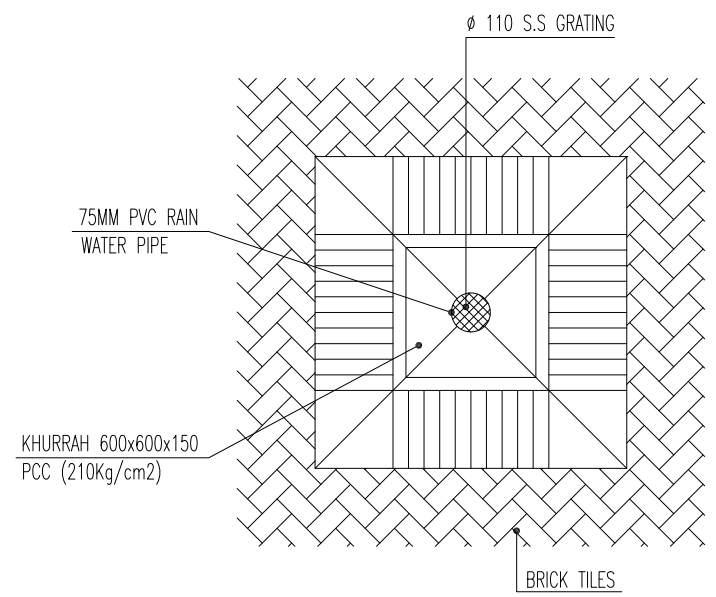

KHURRAH PLAN

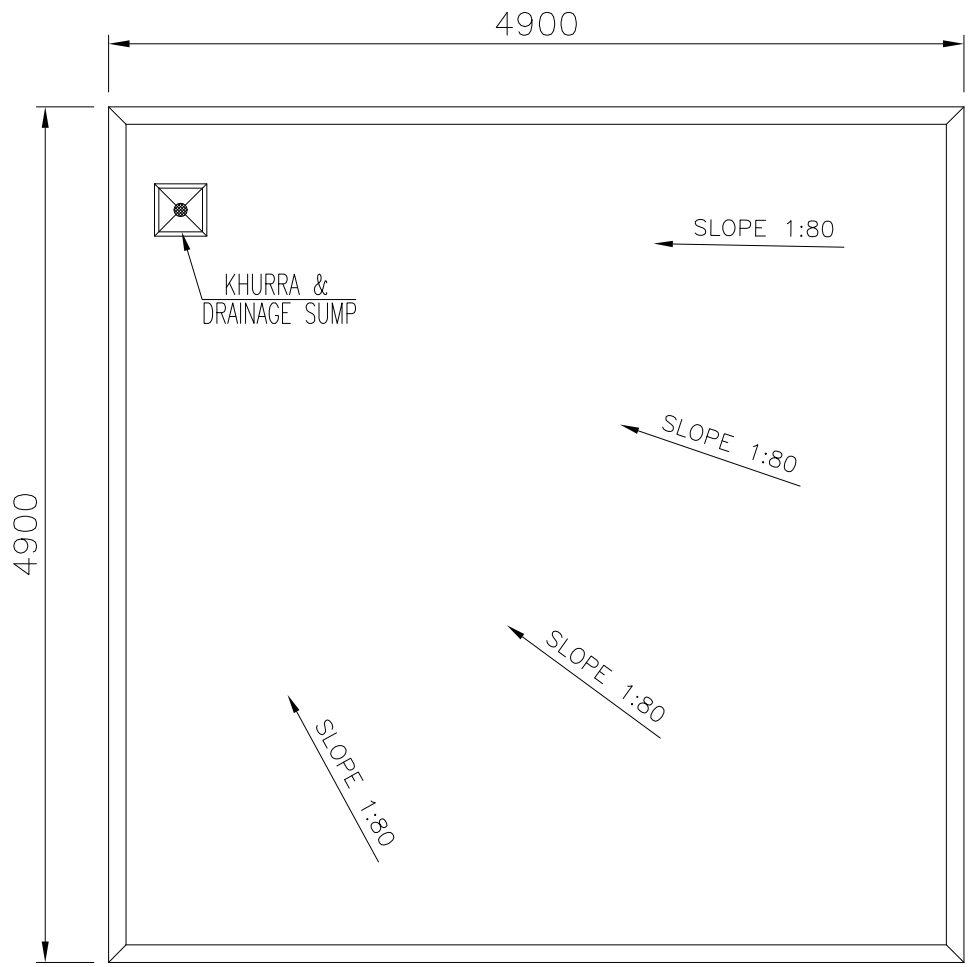

MICROWAVE STATION HUT ROOF TOP PLAN

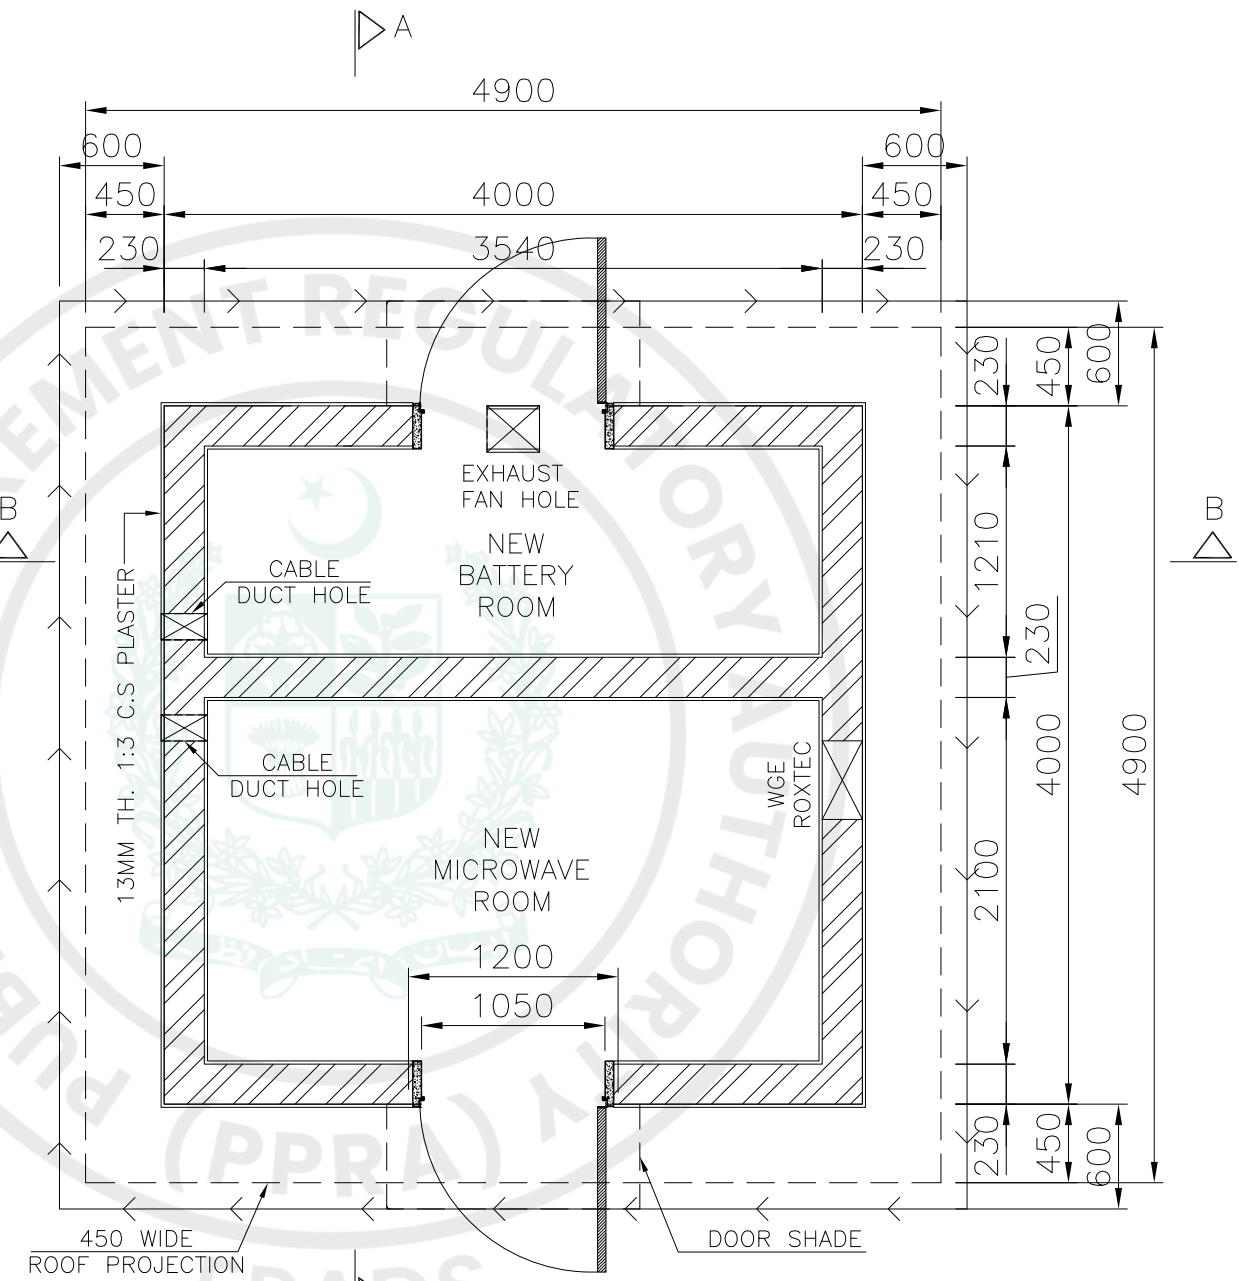

MICROWAVE STATION HUT PLAN VIEW

01	13-12-24	REVISED					
-	17-10-24	FIRST ISSUE					
REV	DATE	DESCRIPTION	CAD	DGN	SL	CKD	APD

REVISIONS

EMPLOYER:


NATIONAL TRANSMISSION & DESPATCH COMPANY LIMITED

CONSULTANT:



CONTRACTOR:



SUBCONTRACTOR:

HUAWEI TECHNOLOGIES CO.LTD.
 HUAWEI

PROJECT:
 ADB-202R-2019:PROCUREMENT OF PLANT, DESIGN, SUPPLY, INSTALLATION, TESTING, AND COMMISSIONING OF SCADA PHASE-3 AND REVENUE METERING SYSTEM (RMS) NTDC LOAN NO.3577-PAK: SECOND POWER TRANSMISSION INVESTMENT PROGRAM, TRANCHE-2

DRAWING TITLE:
**MICROWAVE STATION
 120M GUYED MAST TOWER
 HUT PLAN VIEW & HUT ROOF TOP PLAN**





SCALE: **AS SHOWN**

SITE ADDRESS:
 220 KV GRID STATION ISLAMABAD PESHAWAR ROAD (SANGJANI)

SITE I.D.
 ISPR 220KV

SCALE	DRAWN	DESIGNED	CHECKED	APPROVED	DATE
AS SHOWN	M.K	S. ARSALAN	SHOAB	F.A.KHAIRI	17-10-24


JOB NO.	DRAWING NO.	REV.
---	LDP-III-A-SR116-DWG-0005	01

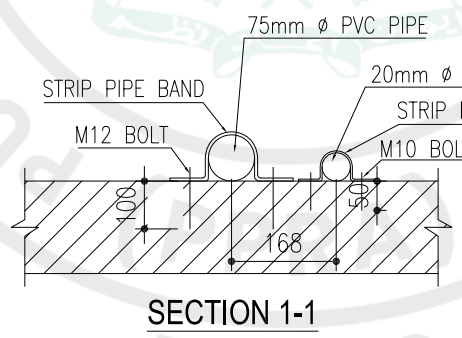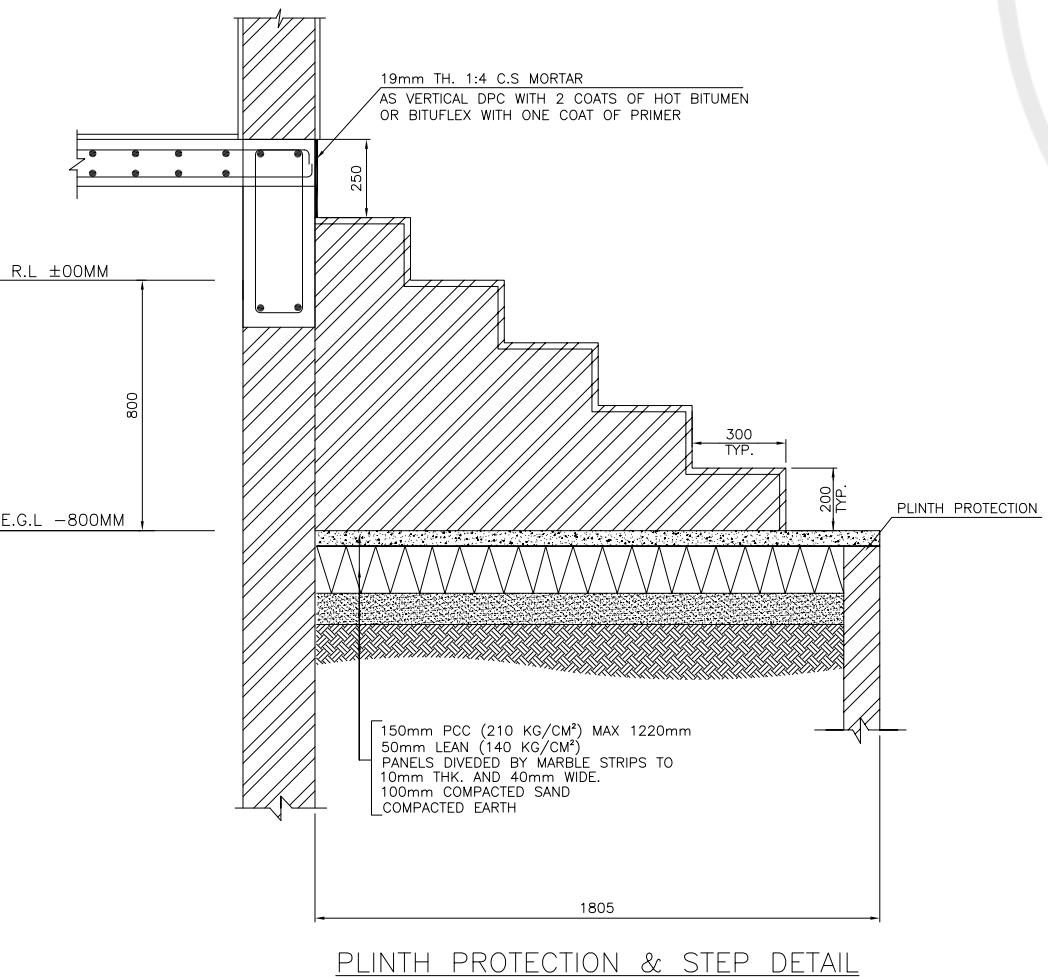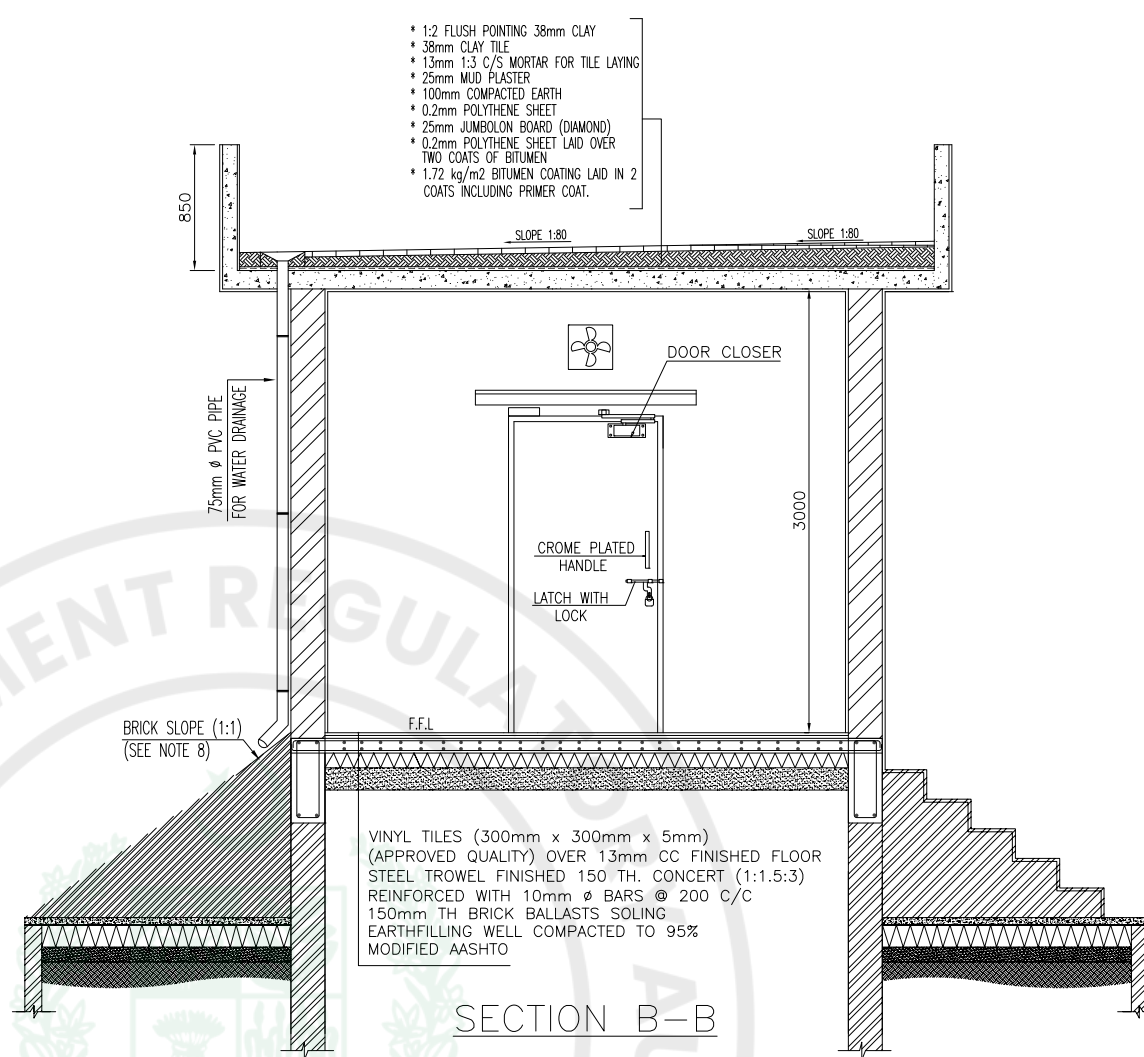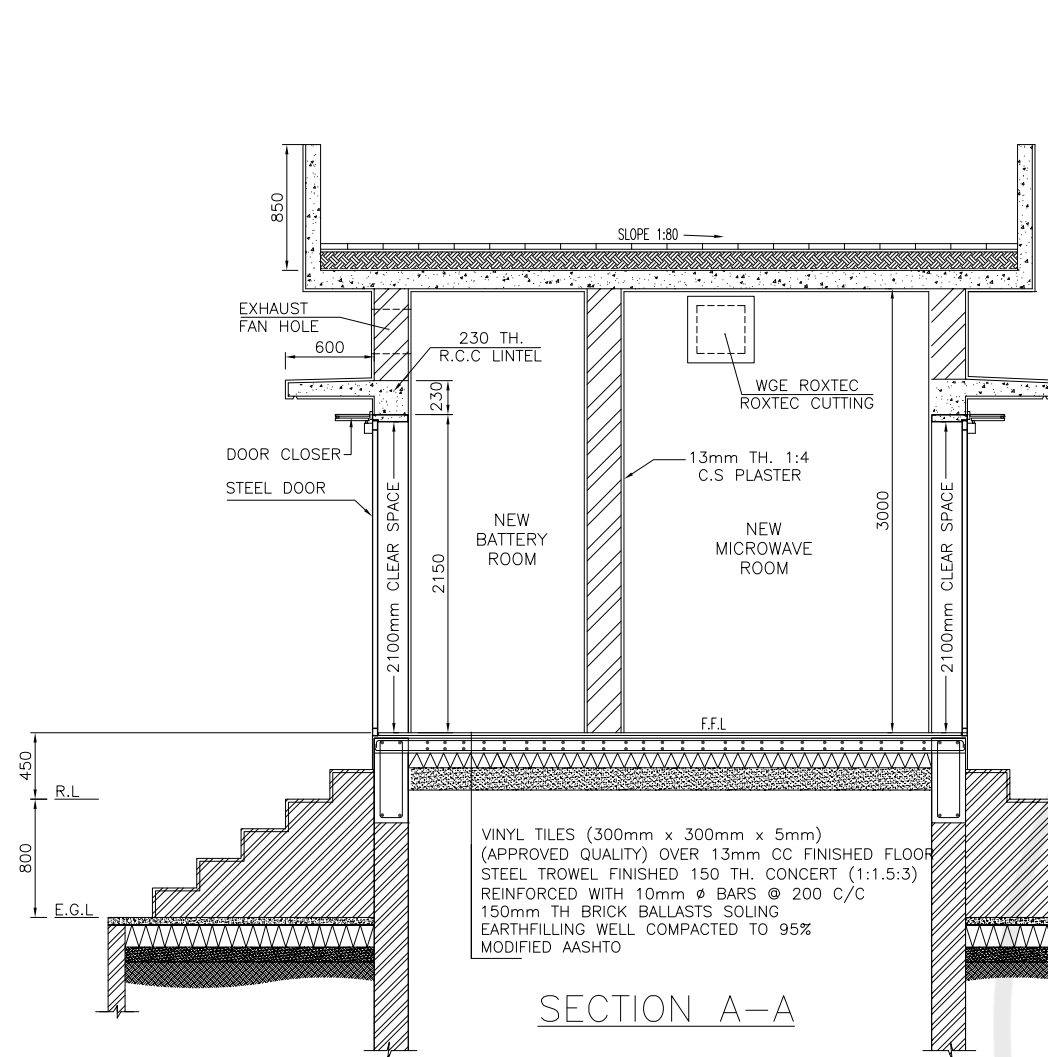

NOTES:

1. GRADATION OF FILL MATERIAL SHALL BE AS PER GEO-TECHNICAL INVESTIGATION REPORT.
2. CLAYEY SOIL SHALL NOT BE USED FOR BACKFILLING IN ANY CASE.
3. ACCUMULATION OF WATER ON BACKFILL AREAS SHALL BE AVOIDED.
4. BACKFILLING & COMPACTION SHALL BE IN SUCCESSIVE LAYERS OF NOT MORE THAN 150mm AS PER SOIL REPORT.
5. DRY DENSITY OF THE BACKFILL ACHIEVED AFTER COMPACTION SHALL NOT BE LESS THAN 95% OF MODIFIED AASHTO DRY DENSITY.
6. EXTERIOR FINISH ALL FAIR FACE & PLASTERED SURFACES TO BE PROVIDED WITH 2 COATS OF WEATHER SHIELD APPROVED BY THE CLIENT.
7. INTERIOR FINISH 3 COATS (ICI DULUX OR EQUIVALENT) BEST QUALITY PAINT OVER PROPERLY PREPARED SURFACE.
8. APPLY PLASTER OF CEMENT-SAND IN RATIO 1:3 ON BRICK SLOPE.

- * 1:2 FLUSH POINTING 38mm CLAY
- * 38mm CLAY TILE
- * 13mm 1:3 C/S MORTAR FOR TILE LAYING
- * 25mm MUD PLASTER
- * 100mm COMPACTED EARTH
- * 0.2mm POLYTHENE SHEET
- * 25mm JUMBOLON BOARD (DIAMOND)
- * 0.2mm POLYTHENE SHEET LAID OVER TWO COATS OF BITUMEN
- * 1.72 kg/m² BITUMEN COATING LAID IN 2 COATS INCLUDING PRIMER COAT.

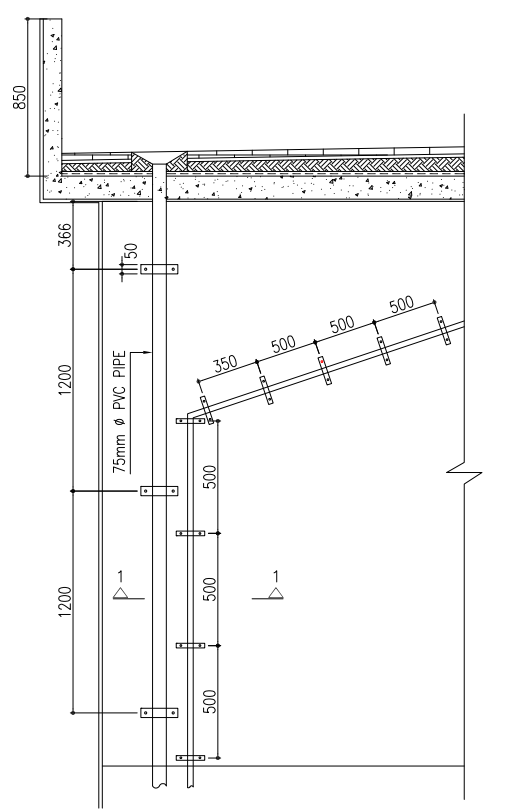

REV	DATE	DESCRIPTION	CAD	DGN	SL	CKD	APD
01	13-12-24	REVISED					
0	17-10-24	FIRST ISSUE					

REVISIONS

EMPLOYER:

NATIONAL TRANSMISSION & DESPATCH COMPANY LIMITED

CONSULTANT:

SAGE Automation **برقآب**

CONTRACTOR:

CMEC **Hitachi Energy**

SUBCONTRACTOR:

HUAWEI TECHNOLOGIES CO.LTD.

PROJECT:
ADB-202R-2019:PROCUREMENT OF PLANT, DESIGN, SUPPLY, INSTALLATION, TESTING, AND COMMISSIONING OF SCADA PHASE-3 AND REVENUE METERING SYSTEM (RMS) NTDC LOAN NO.3577-PAK: SECOND POWER TRANSMISSION INVESTMENT PROGRAM, TRANCHE-2

DRAWING TITLE:
**MICROWAVE STATION
120M GUYED MAST TOWER
HUT SECTIONS & DETAILS**


SCALE: AS SHOWN

SITE ADDRESS:
220 KV GRID STATION ISLAMABAD PESHAWAR ROAD (SANGJANI)


SITE I.D
ISPR 220KV

SCALE	DRAWN	DESIGNED	CHECKED	APPROVED	DATE
AS SHOWN	M.K	S. ARSALAN	SHOAB	F.A.KHAIRI	17-10-24


JOB NO.	DRAWING NO.	REV.
---	LDP-III-A-SR116-DWG-0006	01

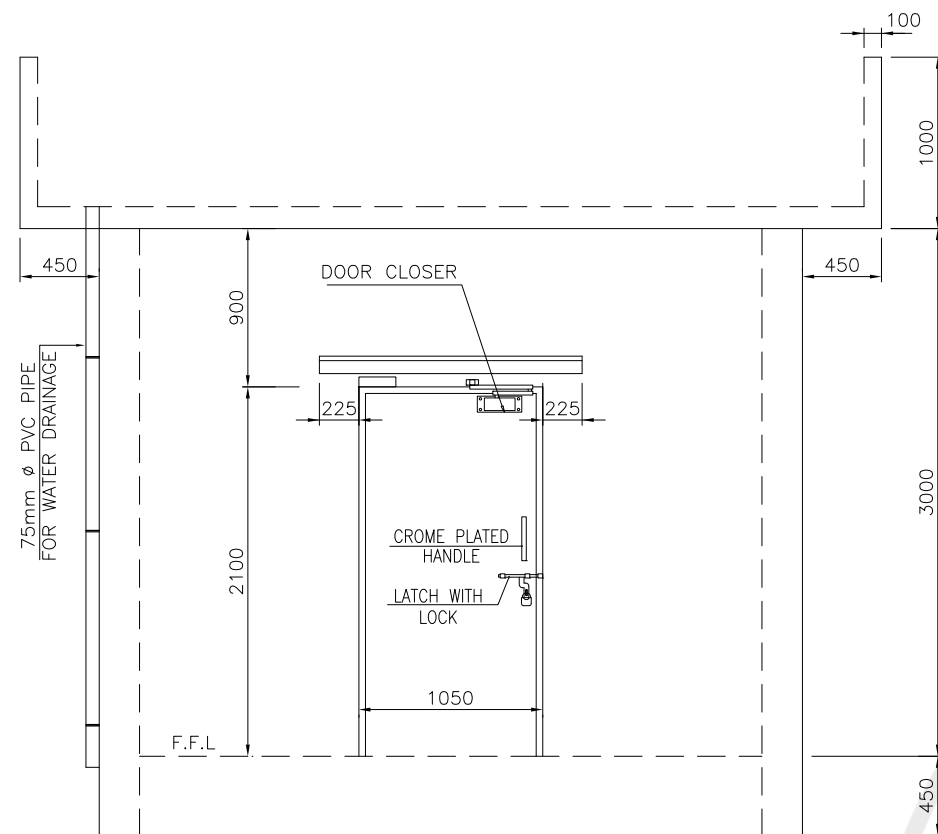


FACE-1

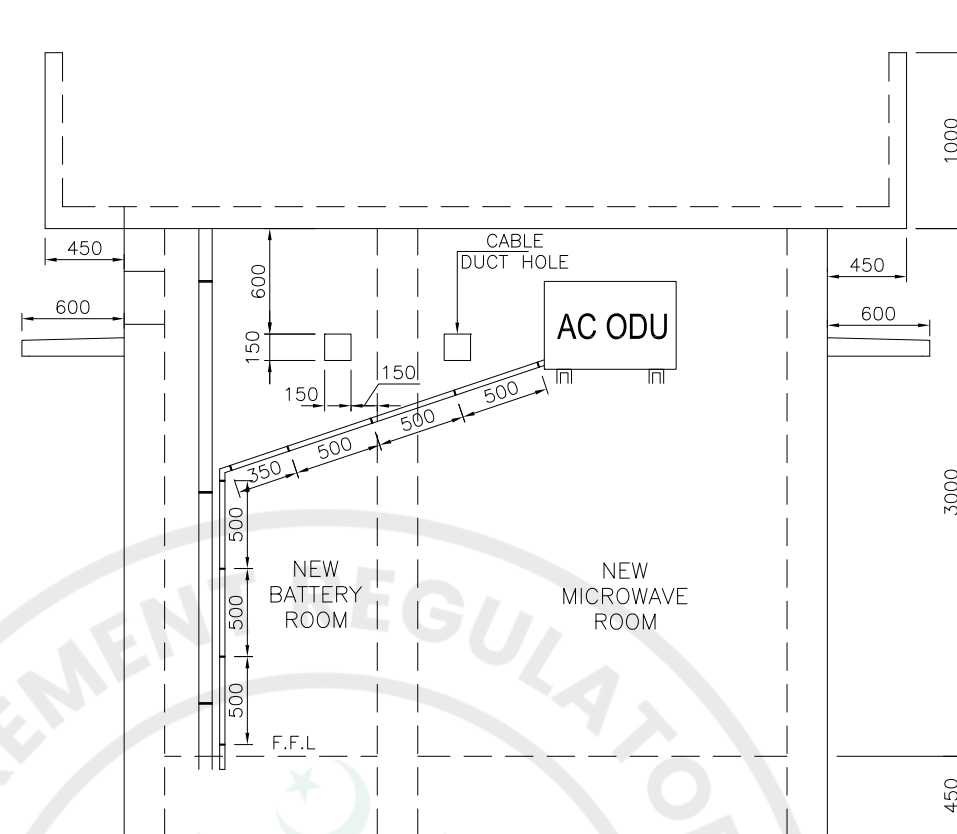


FACE-2

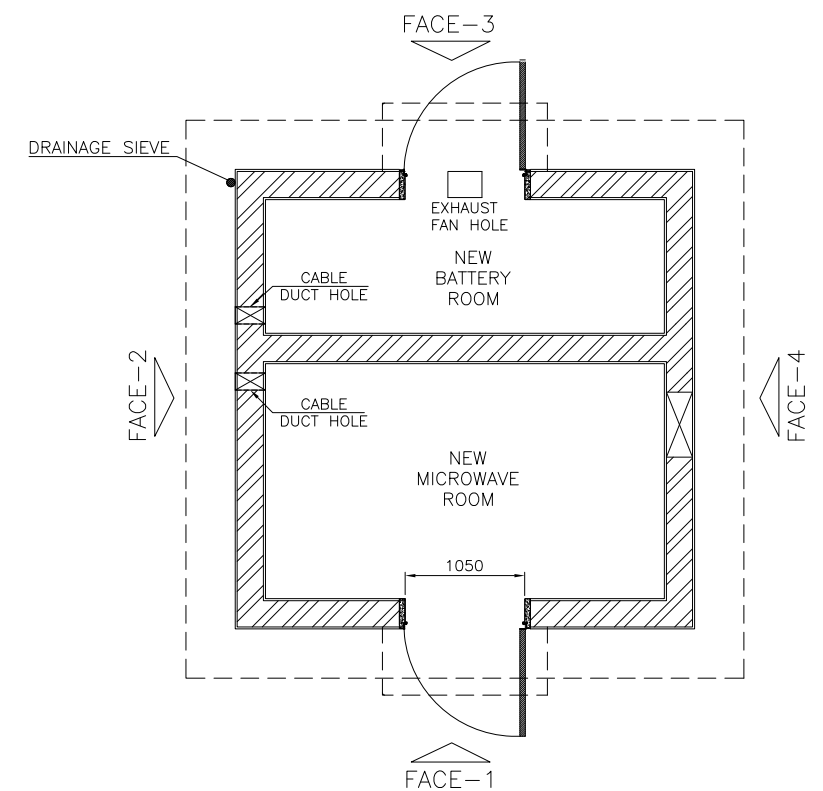

FACE-1

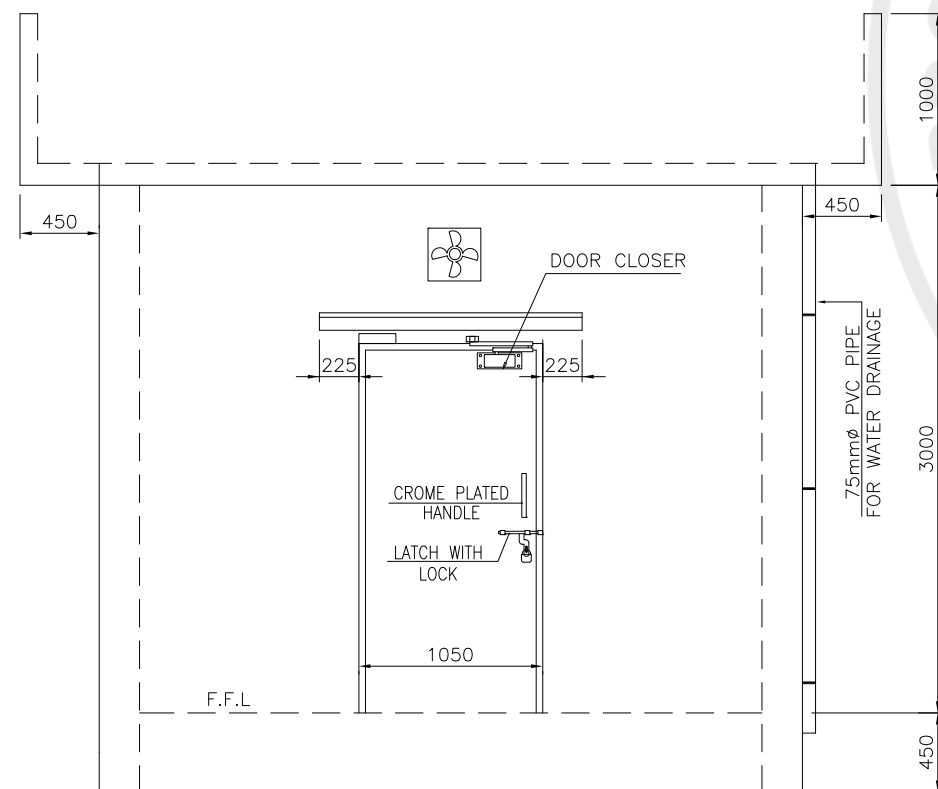

FACE-3

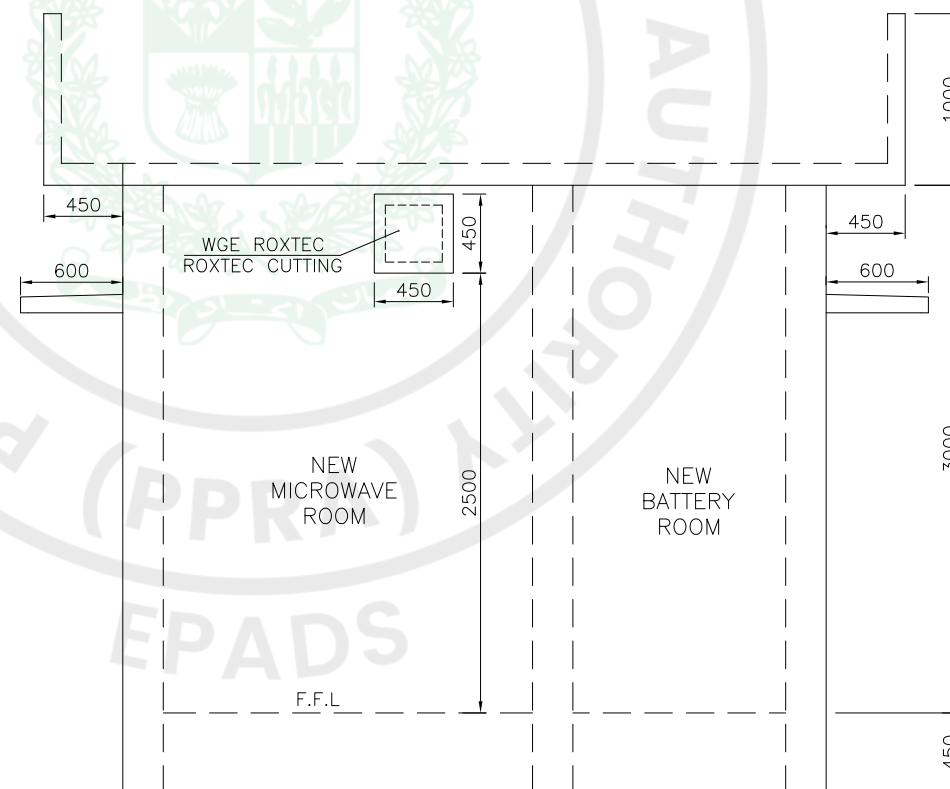

FACE-4

REV	DATE	DESCRIPTION	CAD	DGN	SL	CKD	APD
01	13-12-24	REVISED					
0	17-10-24	FIRST ISSUE					

REVISIONS

EMPLOYER:



CONSULTANT:



CONTRACTOR:



SUBCONTRACTOR:



PROJECT:

ADB-202R-2019:PROCUREMENT OF PLANT, DESIGN, SUPPLY, INSTALLATION, TESTING, AND COMMISSIONING OF SCADA PHASE-3 AND REVENUE METERING SYSTEM (RMS) NTDC LOAN NO.3577-PAK: SECOND POWER TRANSMISSION INVESTMENT PROGRAM, TRANCHE-2

DRAWING TITLE:

MICROWAVE STATION
120M GUYED MAST TOWER
HUT PLAN VIEW / HUT BY FACE ELEVATION

SCALE: AS SHOWN

SITE ADDRESS:

220 KV GRID STATION ISLAMABAD PESHAWAR ROAD (SANGJANI)


SITE I.D

ISPR 220KV

SCALE	DRAWN	DESIGNED	CHECKED	APPROVED	DATE
AS SHOWN	M.K	S. ARSALAN	SHOAB	F.A.KHAIRI	17-10-24
JOB NO.		DRAWING NO.		REV.	
---		LDP-III-A-SR116-DWG-0007		01	

NOTE:

1. EXTERIOR FINISH ALL FAIR FACE & PLASTERED SURFACES TO BE PROVIDED WITH 2 COATS OF WEATHER SHIELD APPROVED BY THE CLIENT.
2. INTERIOR FINISH 3 COATS (ICI DULUX OR EQUIVALENT) BEST QUALITY PAINT OVER PROPERLY PREPARED SURFACE.

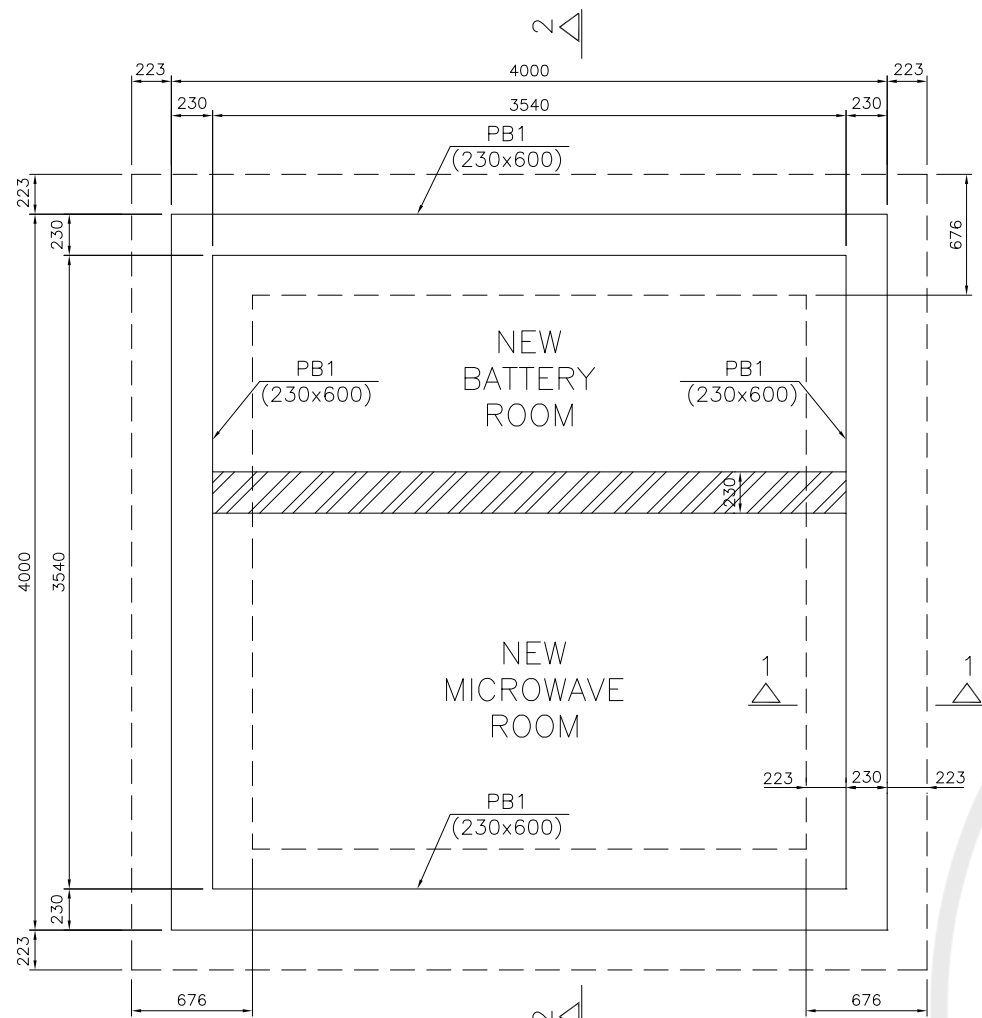

MICROWAVE STATION
HUT FOUNDATION PLAN

- CLEAR CONCRETE COVER FOR BEAM = 40mm.
- CLEAR CONCRETE COVER FOR FOUNDATION = 50mm.

QUANTITIES FOR FOUNDATIONS ARE AS UNDER :


QUANTITIES FOR BTS ROOM:

	UNIT	QUANTITY
(1) EXCAVATION	CM	9.175
(2) BACK FILL	CM	3.09
(3) CONCRETE (1:1.5:3) SOG	CM	2.4
(4) CONCRETE (1:3:6)	CM	2.344
(5) CONCRETE (1:2:4)	CM	0.214
(6) CONCRETE (1:4:8)	CM	1.019
(7) BRICKS	CM	23.35
(8) REINFT. GRADE 60	KG	437
(9) VINYLE TILE	SQM	11.70
13mm CC FINISHED FLOOR	SQM	11.70
150mm TH BRICK BALLASTS SOLING	SQM	11.70
EARTH FILLING WELL COMPACTED TO 95% MODIFIED AASHTO	SQM	11.70
(10) PLASTER (1:4)	SQ	136
(11) ROOF FLOOR (1:1.5:3)	CM	3.6
ROOF FINISH:		
- BITUMEN	PER SQM	22.09
- POLYTHEN	PER SQM	22.09
- PUDDLE CLAY	SQM	22.09
- BRICK TILES	SQM	22.09
- GROUT	SQM	22.09

	BAR NO	SHAPE	BAR Ø	SPACING	CUT LENGTH	QTY	WEIGHT (Kg/m)	WEIGHT (Kgs)	
FLOOR	101	100 3920 100	10	175	4120	(24+24)2=96	0.62	245	
BEAMS	102	300 3920 300	16	--	4520	(2+2)4=16	1.58	114	
	103	150 520	10	200	1580	80	0.62	78	
TOTAL									437 KG

NOTE:


IT IS THE RESPONSIBILITY OF THE CONTRACTOR TO CHECK THE BENDING SCHEDULE ACCORDING TO DIMENSION AT SITE.

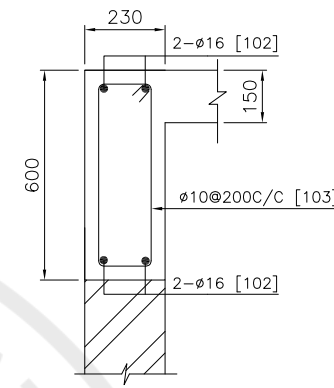


PLINTH BEAM-1
4NOS.

NOTES:


1. GRADATION OF FILL MATERIAL SHALL BE AS PER GEO-TECHNICAL INVESTIGATION REPORT.
2. CLAYEY SOIL SHALL NOT BE USED FOR BACKFILLING IN ANY CASE. ACCUMULATION OF WATER ON BACKFILL AREAS SHALL BE AVOIDED.
3. BACKFILLING & COMPACTION SHALL BE IN SUCCESSIVE LAYERS OF NOT MORE THAN 150mm AS PER SOIL REPORT.
4. DRY DENSITY OF THE BACKFILL ACHIEVED AFTER COMPACTION SHALL NOT BE LESS THAN 95% OF MODIFIED AASHTO DRY DENSITY.

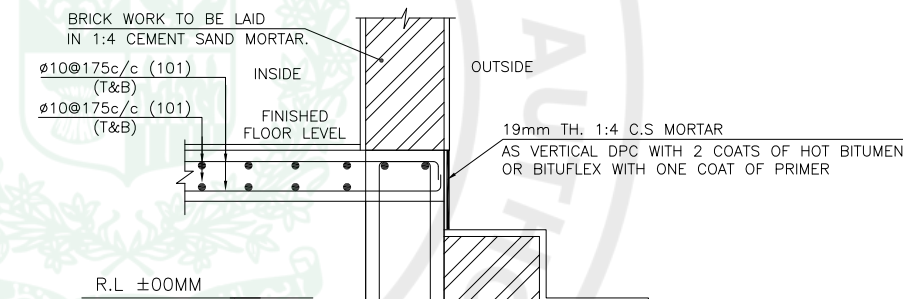

R.L. ±00MM

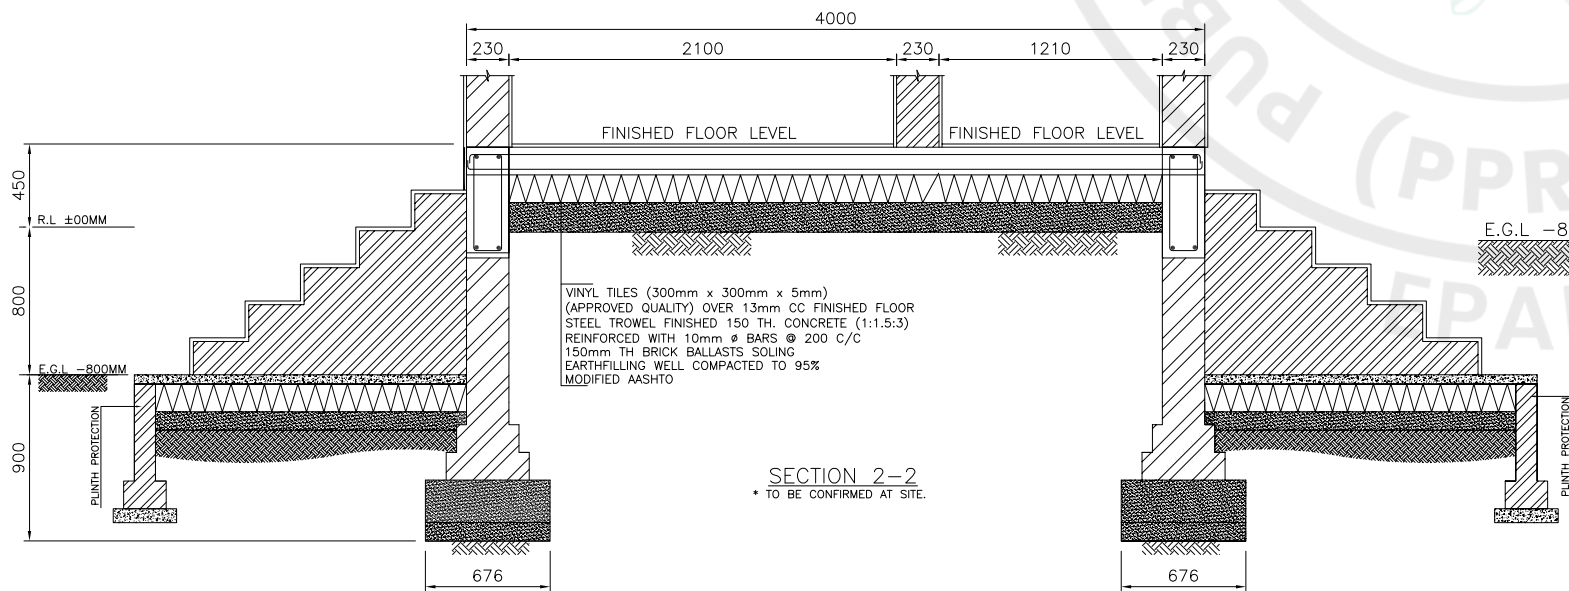

SECTION 2-2
* TO BE CONFIRMED AT SITE.

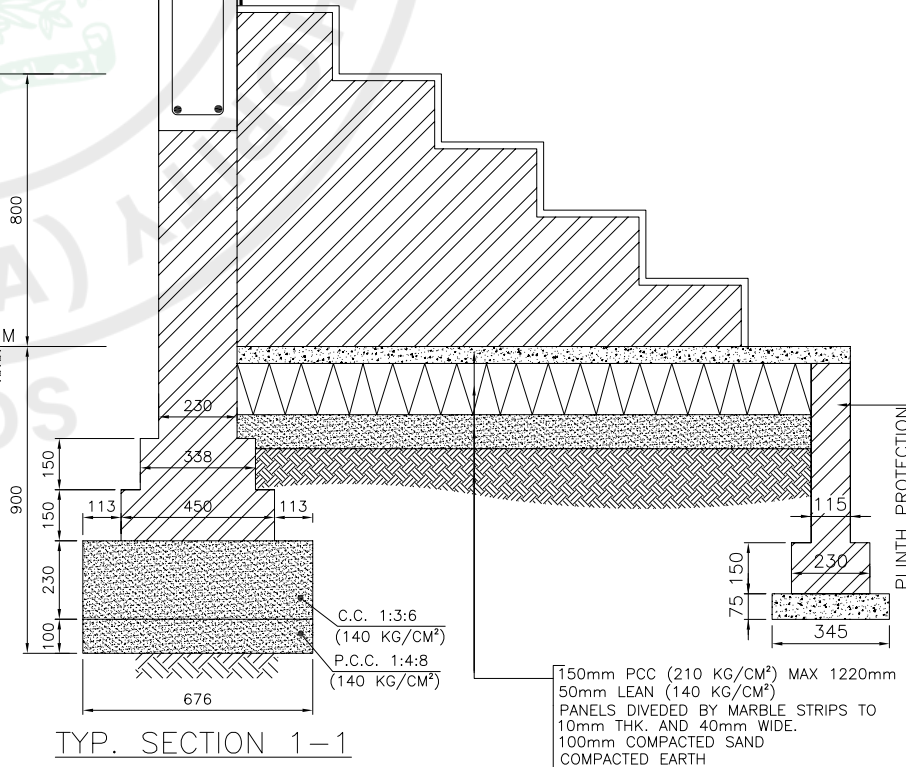

TYP. SECTION 1-1
* TO BE CONFIRMED AT SITE.

REV	DATE	DESCRIPTION	CAD	DGN	SL	CKD	APD
01	13-12-24	REVISED					
-	17-10-24	FIRST ISSUE					

REVISIONS

EMPLOYER:



CONSULTANT:



CONTRACTOR:



SUBCONTRACTOR:



PROJECT:

ADB-202R-2019:PROCUREMENT OF PLANT, DESIGN, SUPPLY, INSTALLATION, TESTING, AND COMMISSIONING OF SCADA PHASE-3 AND REVENUE METERING SYSTEM (RMS) NTDC LOAN NO.3577-PAK: SECOND POWER TRANSMISSION INVESTMENT PROGRAM, TRANCHE-2

DRAWING TITLE:

MICROWAVE STATION
120M GUYED MAST TOWER
HUT FOUNDATION DETAILS

SCALE: AS SHOWN

SITE ADDRESS:



220 KV GRID STATION ISLAMABAD PESHAWAR ROAD (SANGJANI)

SITE I.D

ISPR 220KV

SCALE	DRAWN	DESIGNED	CHECKED	APPROVED	DATE
AS SHOWN	M.K	S. ARSALAN	SHOAB	F.A.KHAIRI	17-10-24

JOB NO.	DRAWING NO.	REV.
-	LDP-III-A-SR116-DWG-0008	01

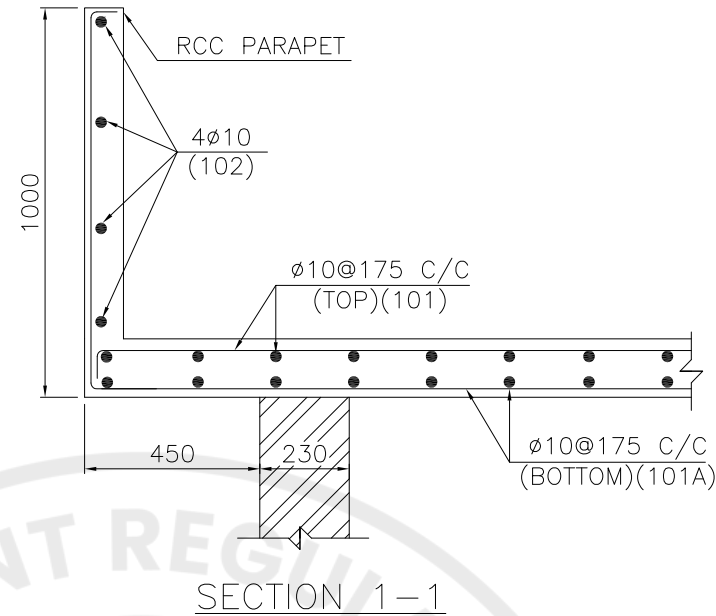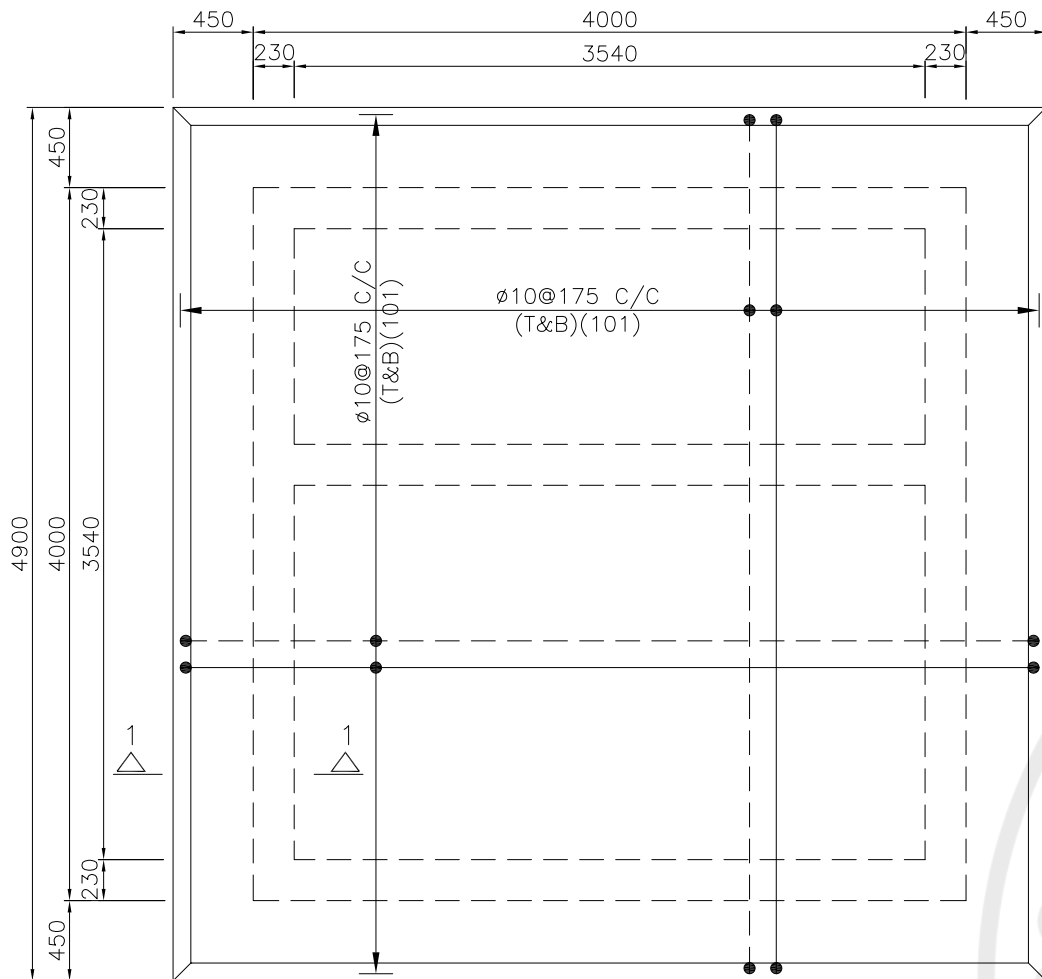

ROOF SLAB REINFORCEMENT PLAN (150TH.)

QUANTITIES

NOS.	DESCRIPTION	UNIT	QUANTITIES
1	CONCRETE	CU.M	4.60
2	STEEL	K.G	467

BAR BENDING SCHEDULE FOR ROOF SLAB

BAR NO	SHAPE	BAR ϕ	SPACING	CUT LENGTH	QTY	WEIGHT (Kg/m)	WEIGHT (Kgs)	
101	100 4820 100	10	175	5020	29+29=58	0.62	181	
101A	50 920 4820 920 50	10	175	6760	40+40=80	0.62	335	
102	600 4820 600	10	-	6020	4x4=16	0.62	60	
TOTAL								576 KG

NOTE:

IT IS THE RESPONSIBILITY OF THE CONTRACTOR TO CHECK THE BENDING SCHEDULE ACCORDING TO DIMENSION AT SITE.

REV	DATE	DESCRIPTION	CAD	DGN	SL	CKD	APD
01	13-12-24	REVISED					
-	17-10-24	FIRST ISSUE					

REVISIONS

EMPLOYER:
 NATIONAL TRANSMISSION & DESPATCH COMPANY LIMITED

CONSULTANT:
 SAGE Automation
 برقاب

CONTRACTOR:
 CMEC
 Hitachi Energy

SUBCONTRACTOR:
 HUAWEI TECHNOLOGIES CO.LTD.
HUAWEI

PROJECT:
ADB-202R-2019:PROCUREMENT OF PLANT, DESIGN, SUPPLY, INSTALLATION, TESTING, AND COMMISSIONING OF SCADA PHASE-3 AND REVENUE METERING SYSTEM (RMS) NTDC LOAN NO.3577-PAK: SECOND POWER TRANSMISSION INVESTMENT PROGRAM, TRANCHE-2

DRAWING TITLE:
MICROWAVE STATION
120M GUYED MAST TOWER
HUT ROOF SLAB REINFORCEMENT PLAN AND DETAILS


SCALE: AS SHOWN

SITE ADDRESS:
220 KV GRID STATION ISLAMABAD PESHAWAR ROAD (SANGJANI)


SITE I.D
ISPR 220KV

SCALE	DRAWN	DESIGNED	CHECKED	APPROVED	DATE
AS SHOWN	M.K	S.ARSALAN	SHOAJB	F.A.KHAIRI	17-10-24

JOB NO.	DRAWING NO.	REV.
-	LDP-III-A-SR116-DWG-0009	01

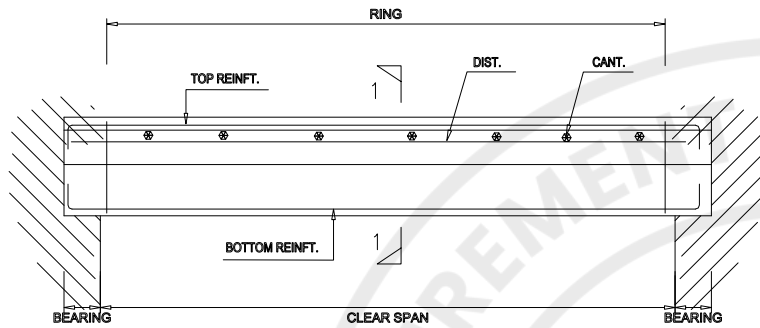

LINTEL ABOVE DOOR

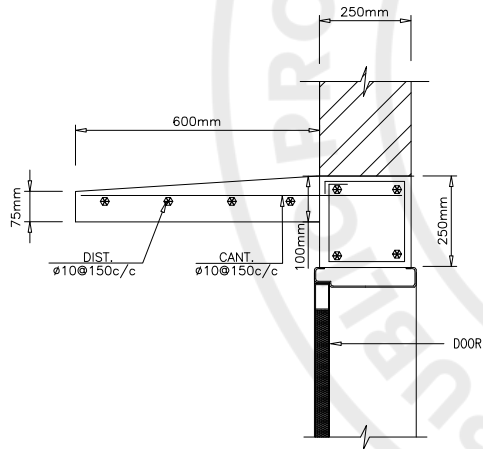

SEC. 1-1

QUANTITIES


NOS.	DESCRIPTION	UNIT	QUANTITIES
1	CONCRETE	CU.M	0.372



LINTEL TYPES



LOCATION	CLEAR SPAN	SIZE	BEARING	TOP REINFT.	BOT REINFT.	RING
ROOM DOOR	1050	225x300	225	2-ø10	2-ø16	ø6-150 c/c
ROOM DOOR	1050	225x300	225	2-ø10	2-ø16	ø6-150 c/c


REV	DATE	DESCRIPTION	CAD	DGN	SL	CKD	APD
*	17-10-24	FIRST ISSUE					

REVISIONS

EMPLOYER:
 NATIONAL TRANSMISSION & DESPATCH COMPANY LIMITED

CONSULTANT:
 SAGE Automation


CONTRACTOR:
 CMEC
 Hitachi Energy

SUBCONTRACTOR:
 HUAWEI TECHNOLOGIES CO.LTD.

PROJECT:
 ADB-202R-2019:PROCUREMENT OF PLANT, DESIGN, SUPPLY, INSTALLATION, TESTING, AND COMMISSIONING OF SCADA PHASE-3 AND REVENUE METERING SYSTEM (RMS) NTDC LOAN NO.3577-PAK: SECOND POWER TRANSMISSION INVESTMENT PROGRAM, TRANCHE-2

DRAWING TITLE:
 MICROWAVE STATION
 120M GUYED MAST TOWER
 LINTEL BEAM REINFORCEMENT DETAIL

SCALE: AS SHOWN



SITE ADDRESS:
 220 KV GRID STATION ISLAMABAD PESHAWAR ROAD (SANGJANI)

SITE I,D


ISPR 220KV

SCALE	DRAWN	DESIGNED	CHECKED	APPROVED	DATE
AS SHOWN	MJK	S, ARSALAN	SHOAB	F.A, KHARI	17-10-24


JOB NO.	DRAWING NO.	REV.
--	LDP-III-A-SR116-DWG-0010	--

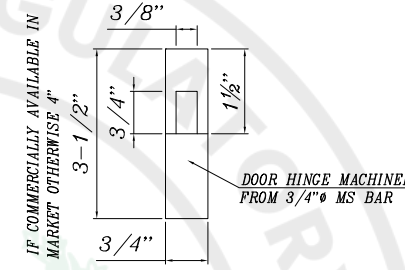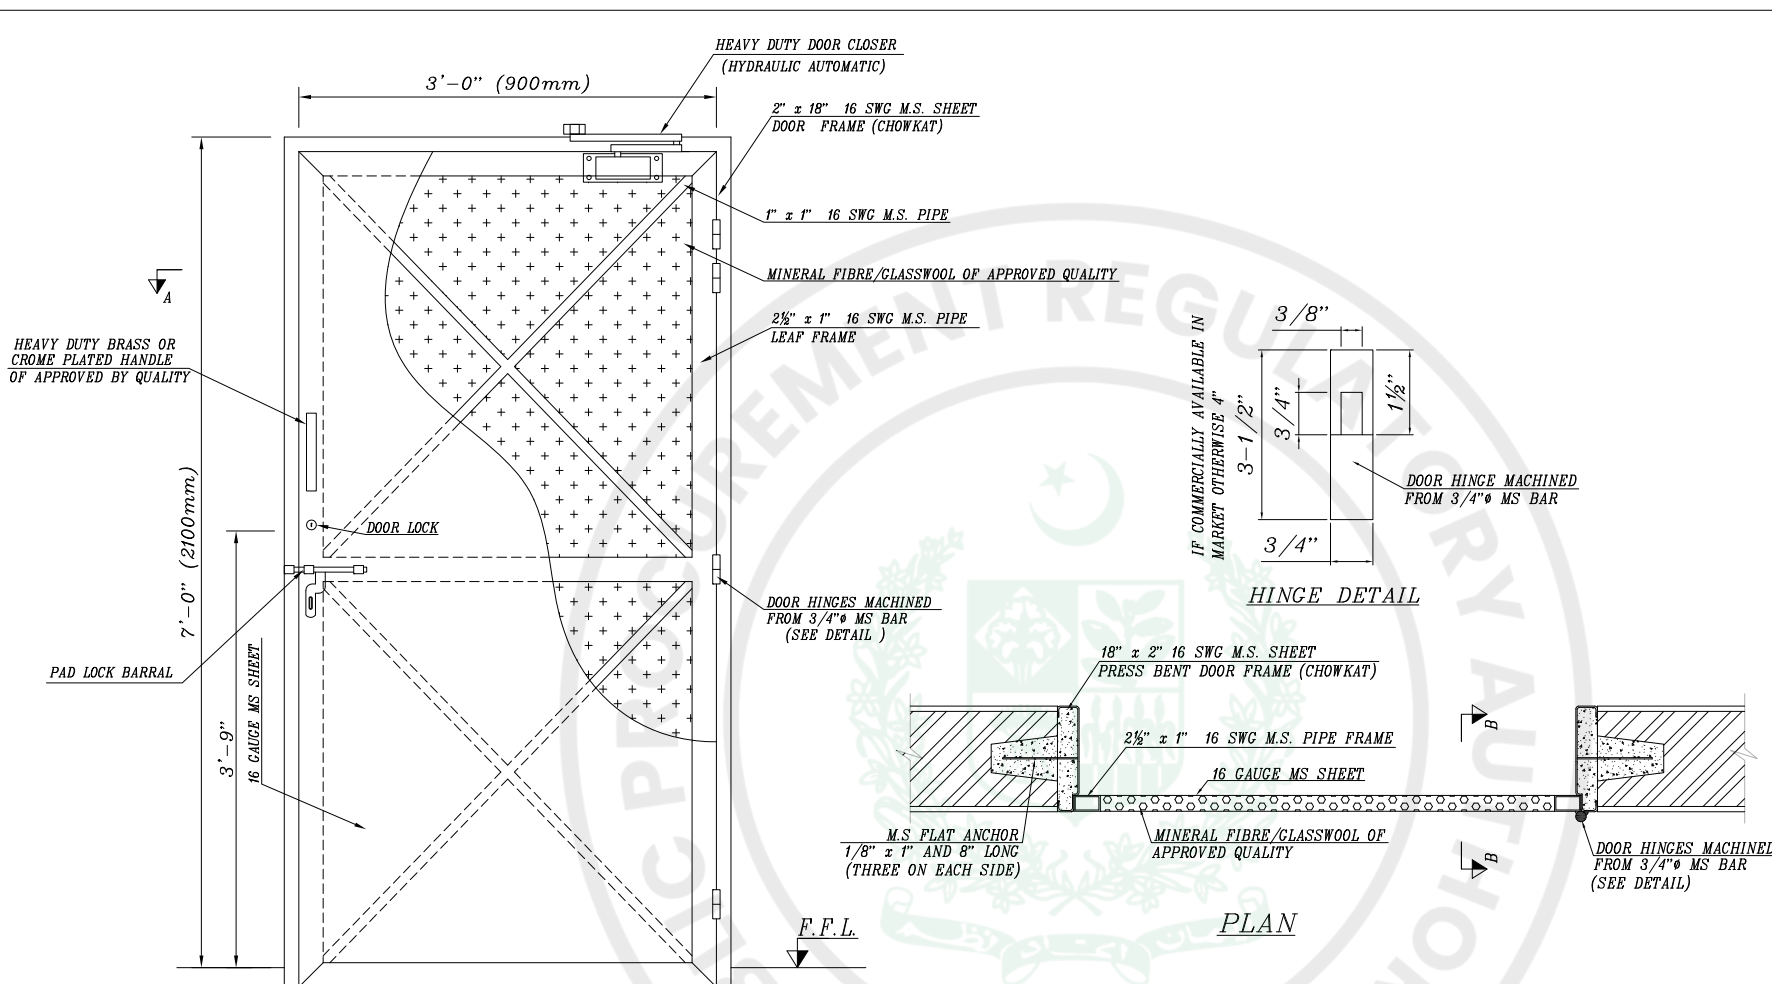

HINGE DETAIL

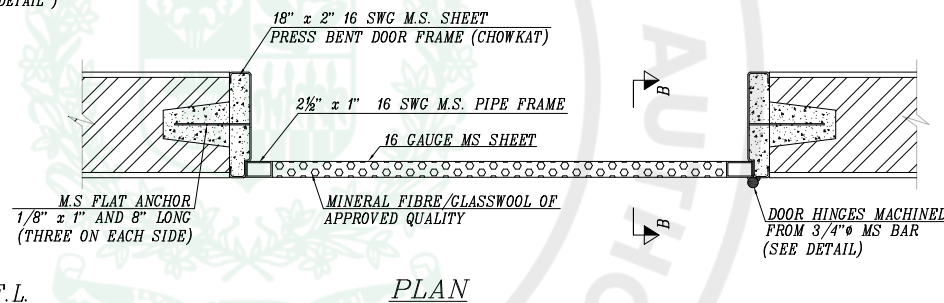


SECTION A (Door Sealing)

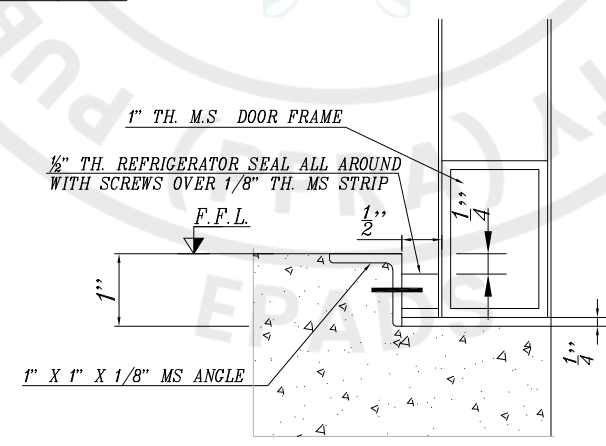


SECTION B (Door Sealing)

- NOTES:
- PAINTING DETAIL**
- 1- ALL MATERIAL USED FOR MANUFACTURE OF STEEL DOORS AND WINDOWS WILL BE RUST FREE.
 - 2- 2 COATS OF RED OXIDE FINISHED WITH 2 COATS OF PRIMER WITH FILLING OF STEEL POUTINE TO PROVIDE A GOOD SURFACE FINISH
 - 3- COATS OF ENAMEL PAINT OR EQUIVALENT WILL BE USED.
- DOOR CLOSER**
- 1- HIGH QUALITY DOOR CLOSER WILL BE PROVIDED FOR BTS ROOM DOOR.
- LOCKS**
- 1- DEAD LOCK USED FOR BTS ROOM DOOR SHALL BE OF CLIENT'S APPROVED QUALITY
- WELDING**
- 1- ALL JOINTS SHALL BE FULL LENGTH AND OF PROPER FINISH.
 - 2- WELDING ELECTRODE SHALL CONFORM TO E60XX
- MATERIAL**
- 1- ALL STRUCTURAL STEEL SHALL CONFORM TO A36.


17-10-24	FIRST ISSUE						
REV	DATE	DESCRIPTION	CAD	DSN	SL	GRD	APD
REVISIONS							
EMPLOYER:							
NATIONAL TRANSMISSION & DESPATCH COMPANY LIMITED							
CONSULTANT:							
SAGE Automation							
CONTRACTOR:							
CMEC							
Hitachi Energy							
SUBCONTRACTOR:							
HUAWEI TECHNOLOGIES CO.LTD.							
PROJECT:							
ADB-202R-2019:PROCUREMENT OF PLANT, DESIGN, SUPPLY, INSTALLATION, TESTING, AND COMMISSIONING OF SCADA PHASE-3 AND REVENUE METERING SYSTEM (RMS) NTDC LOAN NO.3577-PAK; SECOND POWER TRANSMISSION INVESTMENT PROGRAM, TRANCHE-2							
DRAWING TITLE:							
MICROWAVE STATION 120M GUYED MAST TOWER HUT PROPOSED DOOR DETAILS							
SCALE: AS SHOWN							
SITE ADDRESS:							
220 KV GRID STATION ISLAMABAD PESHAWAR ROAD (SANGJANI)							
SITE I.D							
ISPR 220KV							
SCALE	DRAWN	DESIGNED	CHECKED	APPROVED	DATE		
AS SHOWN	M.K	S. ARSALAN	SHOAB	F.A.KHARRI	17-10-24		
JOB NO.	DRAWING NO.						
--	LDP-BILA-SR116-DWG-0011						

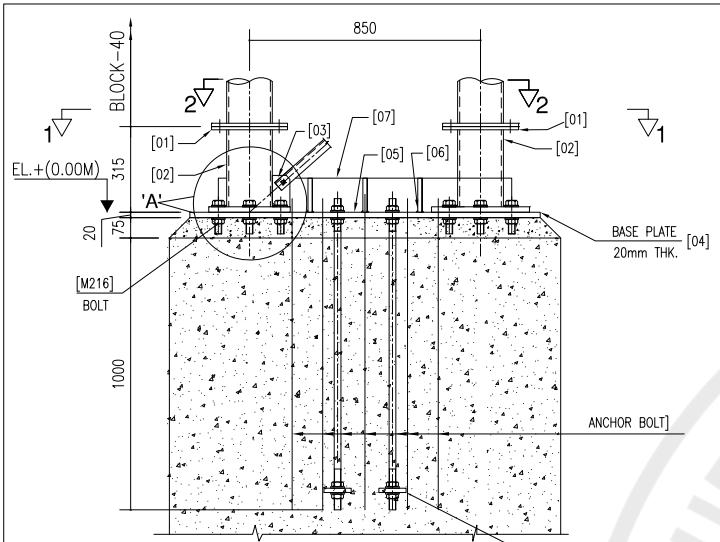


BASE PLATE & STUB DETAIL

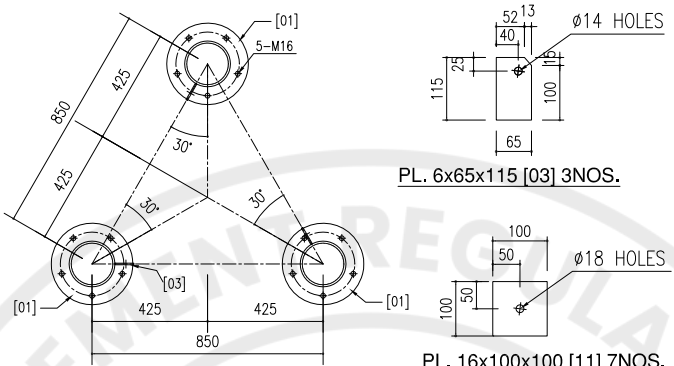


SECTION 2-2

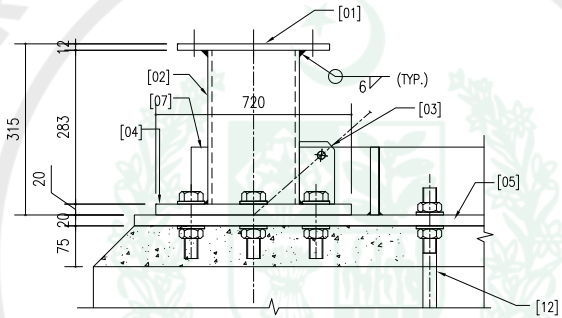

STUB DETAIL 'A'

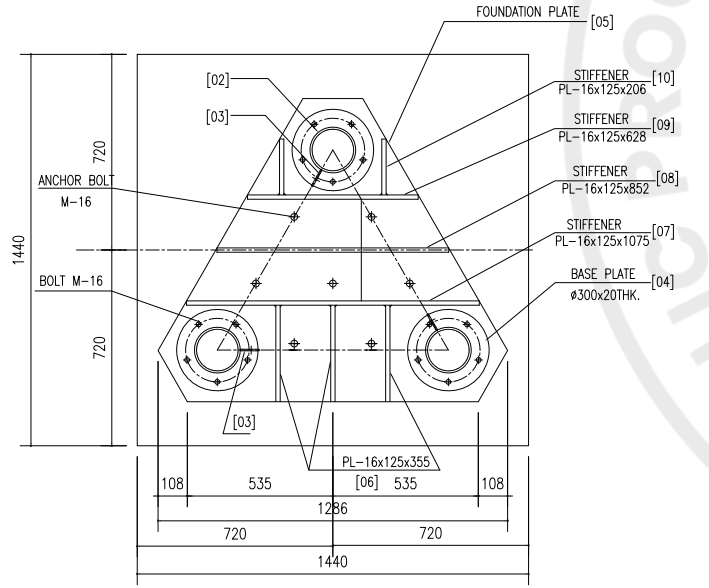


SECTION 1-1

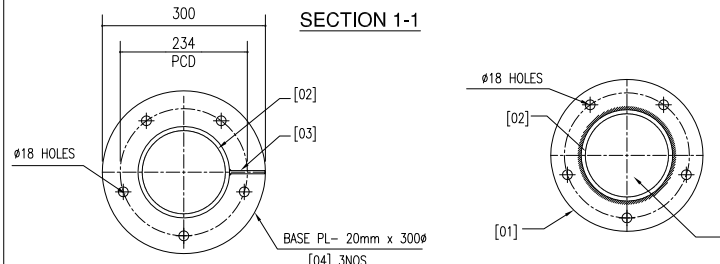


PL. 20x300 DIA. [04] 3NOS. **PL. 12x280 DIA. [01] 3NOS.**

LIST OF MATERIAL									
PART NO.	DESCRIPTION	SECTION	LENGTH	QTY.		WEIGHT IN K.G.		REMARKS	
				R	L	1 PIECE	TOTAL		
01	FLANGE PLATE	PL12 x 280 DIA	---	3		5.80	18		
02	STUB	6" N.D.PIPE (168.28x7.6)	283	3		8.54	26		
03	GUSSET PLATE	PL-6 x 65	115	3		0.35	1		
04	BASE PLATE	PL-20 x 300 DIA	---	3		11.09	33		
05	FOUNDATION PLATE	PL-20 x 1115	1287	1		282.31	225		
06	STIFFENER	PL-16 x 125	355	3		5.57	17		
07	STIFFENER	PL-16 x 125	1075	1		16.87	17		
08	STIFFENER	PL-16 x 125	852	1		13.40	13		
09	STIFFENER	PL-16 x 125	628	1		9.87	10		
10	STIFFENER	PL-16 x 125	206	2		3.23	6		
11	ANCHOR PLATE	PL- 16 x 100	100	7		1.25	9		
12	WITH 4NUTS & 4WASHERS M-16x110		---	15		0.82	6		
	WITH 4NUTS & 4WASHERS M-16x1150 ANCHOR BOLTS		---	7		5.43	82		
							TOTAL = 463		

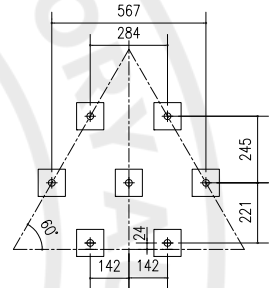

ANCHOR PLATE PLAN

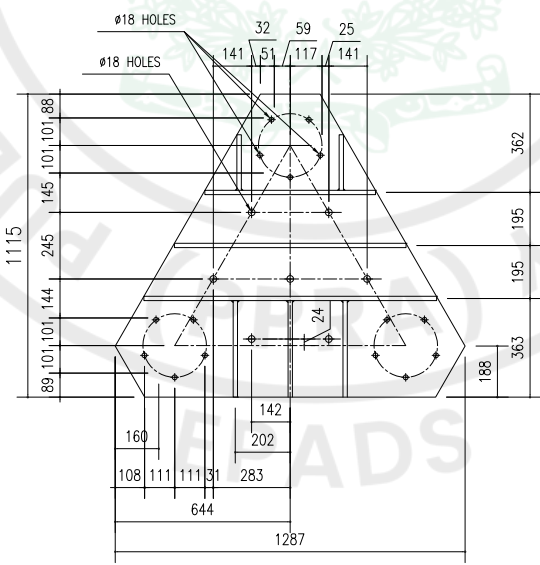


ANCHOR BOLT DETAIL (7 NOS.) [12]
M16x1150 STD.WITHWORTH THREADS

REV	DATE	DESCRIPTION	CAD DGN	SL	CKD	APD
-	17-10-24	FIRST ISSUE				
REVISIONS						
EMPLOYER:						
CONSULTANT:						
CONTRACTOR:						
SUBCONTRACTOR:						
PROJECT:						
ADB-202R-2019: PROCUREMENT OF PLANT, DESIGN, SUPPLY, INSTALLATION, TESTING, AND COMMISSIONING OF SCADA PHASE-3 AND REVENUE METERING SYSTEM (RMS) NTDC L OAW NO.3574-PAK- SECOND POWER TRANSMISSION INVESTMENT PROGRAM, TRANCHE-2						
DRAWING TITLE:						
MICROWAVE STATION 120M GUYED MAST TOWER STUB & BASE PLATE DETAILS						
SCALE:						
NTS						
SITE ADDRESS:						
220 KV GRID STATION ISLAMABAD PESHAWAR ROAD (SANGJANI)						
SITE I.D.						
ISPR 220KV						
SCALE	DRAWN	DESIGNED	CHECKED	APPROVED	DATE	
AS SHOWN	MJK	SAJID	KAMRANZ	F.A.KHAIRI	17-10-24	
JOB NO.			DRAWING NO.			REV.
---			LDP-220KV-2019-001			--


LIST OF MATERIAL

PART NO.	DESCRIPTION	SECTION	LENGTH	QTY.		WEIGHT IN K.G.		REMARKS
				R	L	1 PIECE	TOTAL	
01	TEMPLATE	PL- 543x8	626	1		16.01	16	
02	TEMPLATE	PL- 600x5	600	9		14.13	127	
TOTAL = 143								

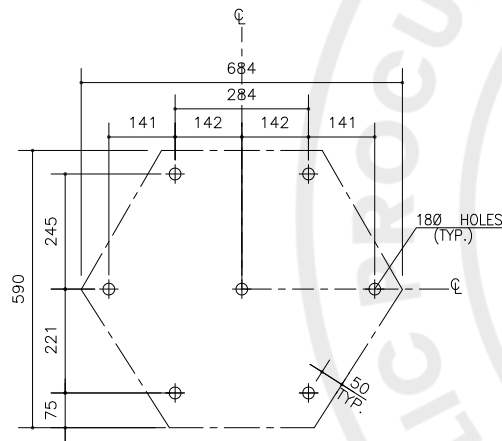

**TEMPLATE [01]
FOR TOWER BASE FOUNDATION**


SCALE: 1:10

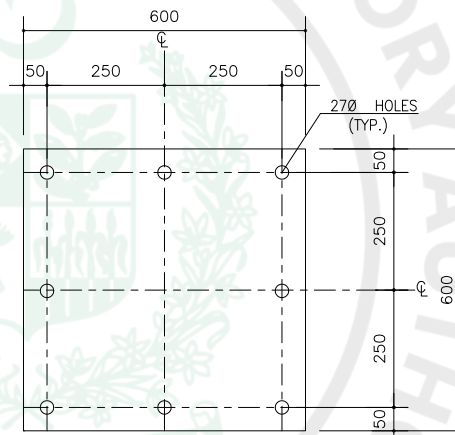

**TEMPLATE [02]
FOR GUYS BASE FOUNDATION**

SCALE: 1:10

REV	DATE	DESCRIPTION	CAD	DCN	SL	CHKD	APPD
0	17-10-24	FIRST ISSUE					
REVISIONS							
EMPLOYER:							
NATIONAL TRANSMISSION & DESPATCH COMPANY LIMITED							
CONSULTANT:							
CONTRACTOR:							
SUBCONTRACTOR:							
HUAWEI TECHNOLOGIES CO.LTD. HUAWEI							
PROJECT:							
ADB-202R-2019: PROCUREMENT OF PLANT, DESIGN, SUPPLY, INSTALLATION, TESTING, AND COMMISSIONING OF SCADA PHASE-3 AND REVENUE METERING SYSTEM (RMS) NTDC LOAN NO.3577-PAK; SECOND POWER TRANSMISSION INVESTMENT PROGRAM, TRANCHE-2							
DRAWING TITLE:							
MICROWAVE STATION 120M GUYED MAST TOWER BASE TEMPLATE [01 & 02]							
SCALE: 1:10							
SITE ADDRESS:							
220 KV GRID STATION ISLAMABAD PESHAWAR ROAD (SANGJANI)							
SITE I.D							
ISPR 220KV							
SCALE	DRAWN	DESIGNED	CHECKED	APPROVED	DATE		
AS SHOWN	HRM:K	KF	RSL	DSA	17-10-24		
JOB NO.	DRAWING NO.		REV.				
	LD-III-A-SR116-GM/120M/T/P-01		0				

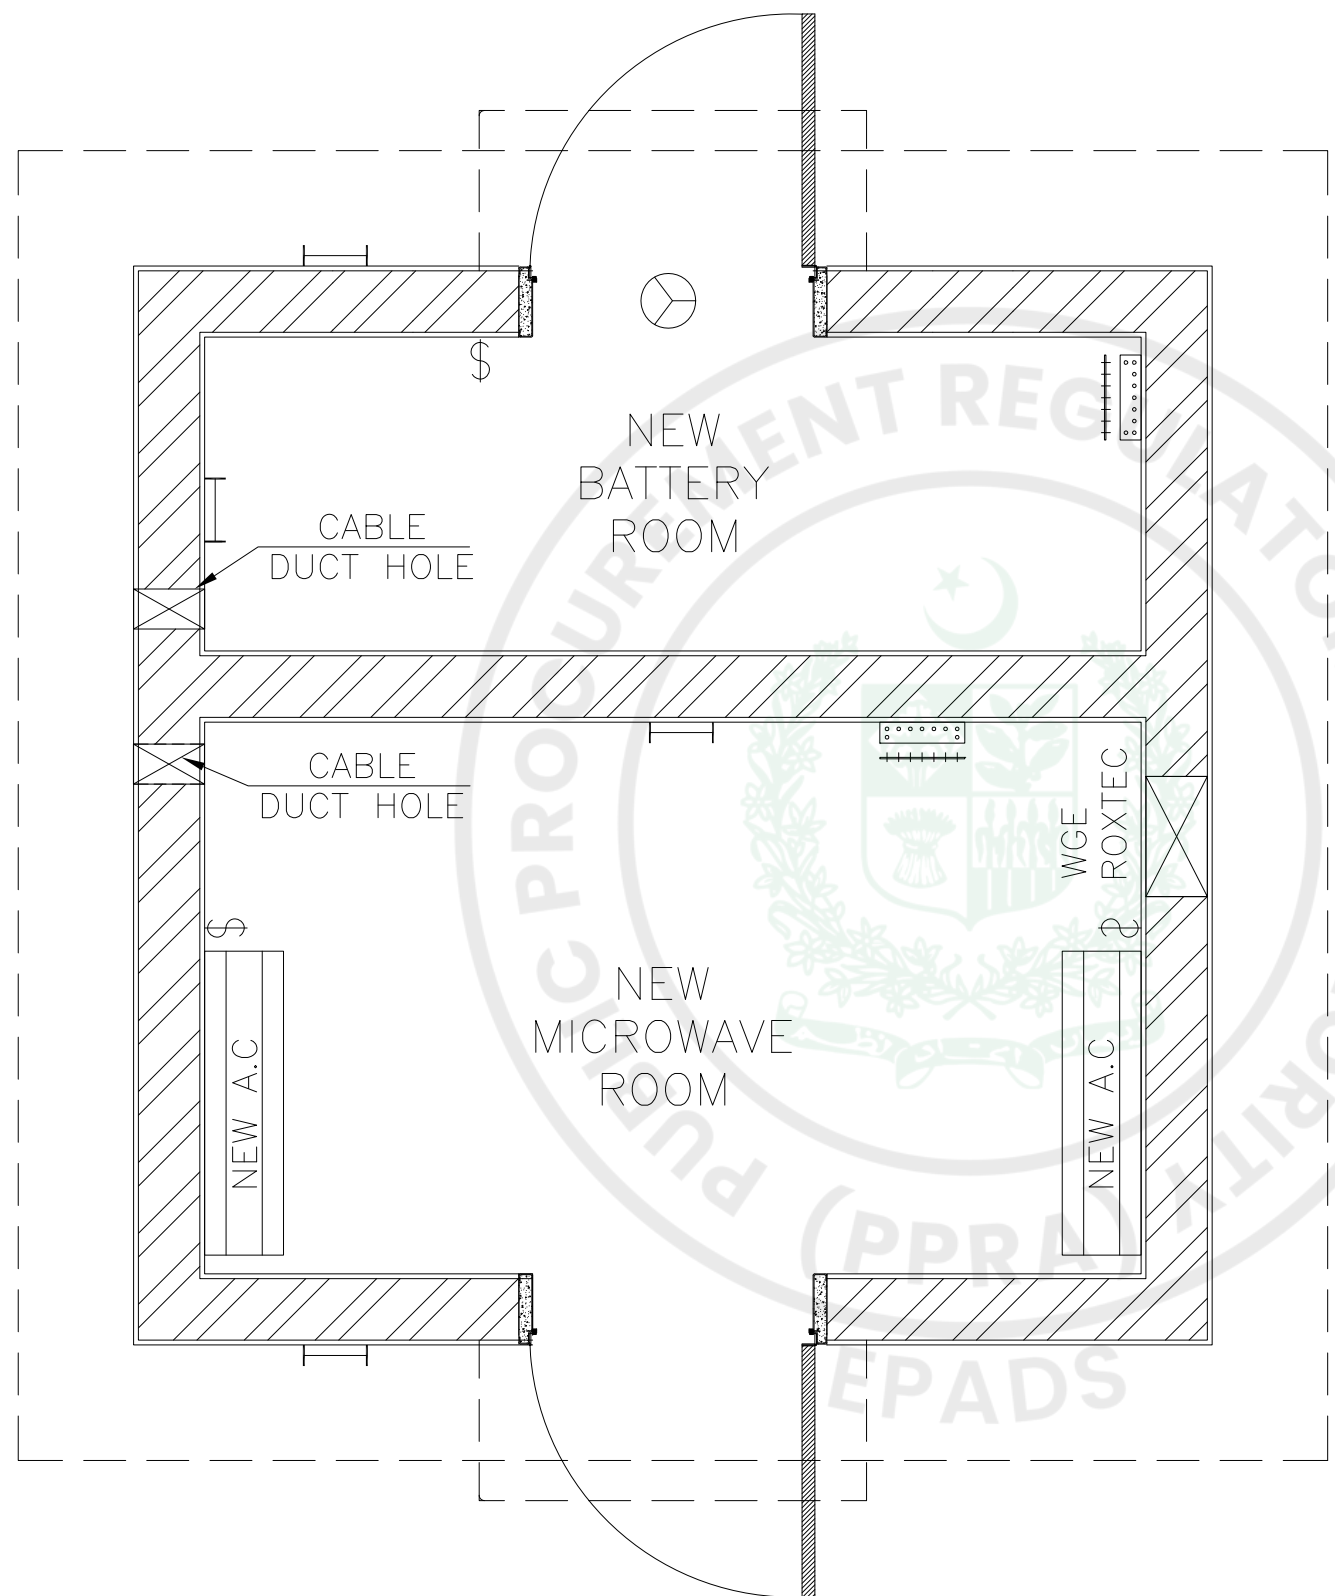

MICROWAVE STATION
HUT ELECTRICAL LAYOUT PLAN

LEGEND		
NAME	SYMBOL	QUANTITY
LIGHTS	⊢	4
AC POWER SOCKETS(2x240)	\$	2
AC POWER SOCKETS(1x240)	\$	1
BUS BAR	⊢	2
A.C	▭	2
EXHAUST FAN	⊙	1

REV	DATE	DESCRIPTION	CAD	DGN	SL	CKD	APD
01	13-12-24	REVISED					
-	17-10-24	FIRST ISSUE					

REVISIONS

EMPLOYER:


NATIONAL TRANSMISSION & DESPATCH COMPANY LIMITED

CONSULTANT:



CONTRACTOR:



SUBCONTRACTOR:

HUAWEI TECHNOLOGIES CO.LTD.
 HUAWEI

PROJECT:
 ADB-202R-2019:PROCUREMENT OF PLANT, DESIGN, SUPPLY, INSTALLATION, TESTING, AND COMMISSIONING OF SCADA PHASE-3 AND REVENUE METERING SYSTEM (RMS) NTDC LOAN NO.3577-PAK: SECOND POWER TRANSMISSION INVESTMENT PROGRAM, TRANCHE-2


DRAWING TITLE:
**MICROWAVE STATION
 120M GUYED MAST TOWER
 HUT ELECTRICAL LAYOUT PLAN**

SCALE: **AS SHOWN**

SITE ADDRESS:
 220 KV GRID STATION ISLAMABAD PESHAWAR ROAD (SANGJANI)

SITE I.D
 ISPR 220KV

SCALE	DRAWN	DESIGNED	CHECKED	APPROVED	DATE
AS SHOWN	M.K	S. ARSALAN	SHOAB	F.A.KHAIRI	17-10-24
JOB NO.		DRAWING NO.		REV.	
—		LDP-III-A-SR116-DWG-E001		01	

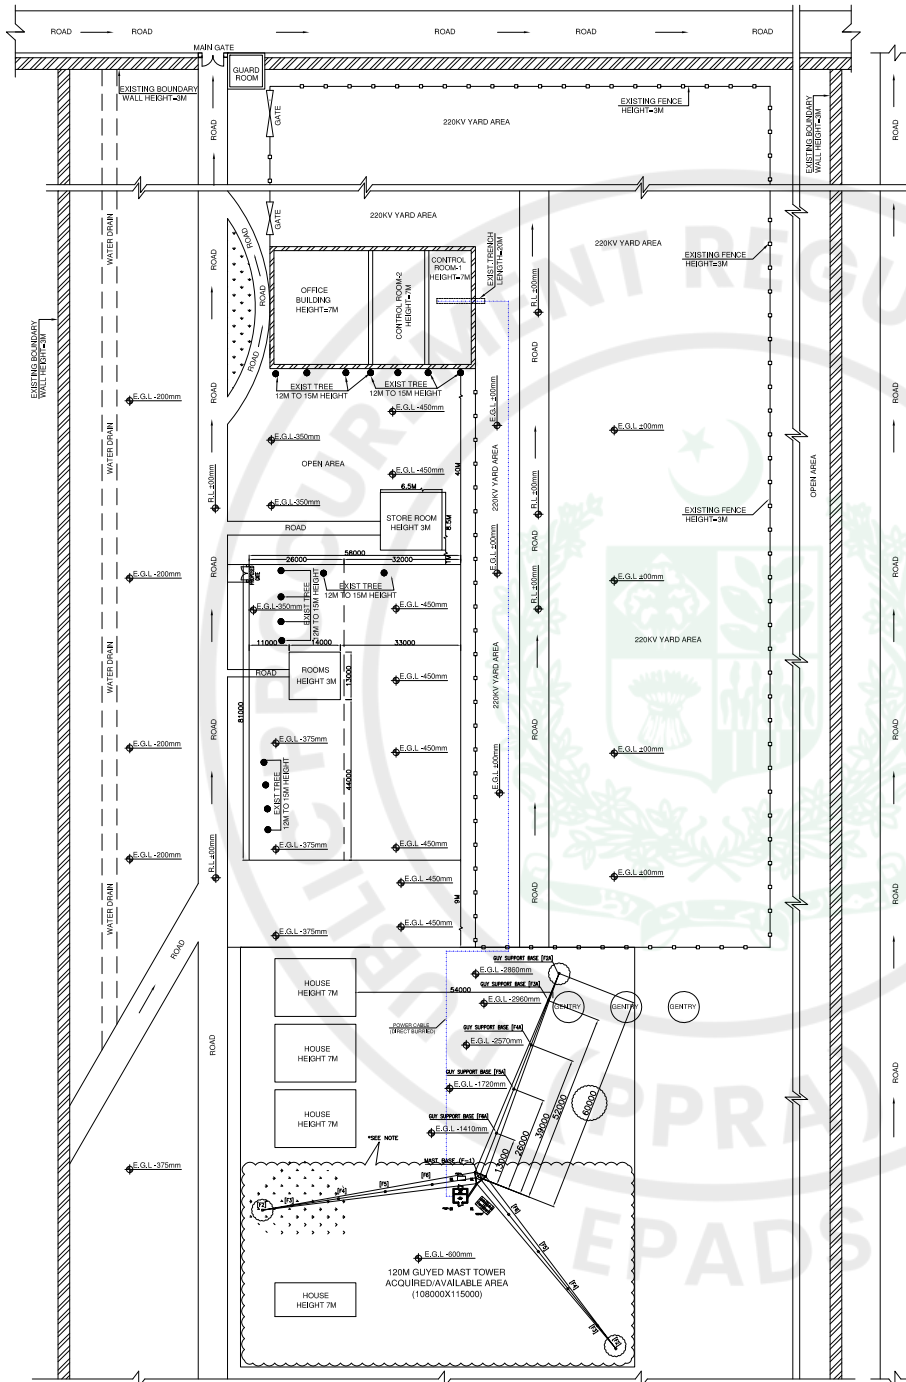

MICROWAVE STATION
PROPOSED CABLE ROUTING SITE LAYOUT PLAN

NOTE:

1. ALL DIMENSIONS ARE IN MM UNLESS NOTED OTHERWISE SPECIFIED.
2. PROPOSED POWER CABLE LENGTH=290M APPROX.
3. EXISTING 20M CABLE TRENCH AVAILABLE FOR PROPOSED NEW POWER CABLE.
4. THE EMPLOYER SHALL PROVIDE THE CLEAR LAND OF 108MX115M AS MENTIONED IN THE LAYOUT FOR NEW MW SITE CONSTRUCTION ANY EXTRA UNUSED MATERIAL SHALL BE REMOVED FROM SITE BY EMPLOYER BEFORE STARTING THE WORK.
5. AC POWER CABLE, SUPPLY, LAYING, TERMINATION AND ANY ASSOCIATED CIVIL ELECTRICAL WORKS INCLUDING TESTING AND EARTHING ARE TO BE PERFORMED BY EMPLOYER.
- * THE GROUND LEVEL OF THE MAIN GUY MAST & THE GUYED WIRES SUPPORTS IN THIS AREA TO BE MAINTAINED AT-600MM.

LEGENDS

R.L	ROAD LEVEL
E.G.L	EXISTING GROUND LEVEL

COORDINATE OF SITE

LONGITUDE	72°50'15.00" E
LATITUDE	33°40'34.14" N

REVISIONS

REV	DATE	DESCRIPTION	CAD	DGN	SL	CKD	APD
03	08-01-24	REVISED					
02	13-12-24	REVISED					
01	09-12-24	REVISED AS PER CLOUD					
*	17-10-24	FIRST ISSUE					

EMPLOYER:

NATIONAL TRANSMISSION & DESPATCH COMPANY LIMITED

CONSULTANT:

SAGE Automation and **برقار**

CONTRACTOR:

CMEC and **Hitachi Energy**

SUBCONTRACTOR:

HUAWEI TECHNOLOGIES CO.,LTD.

PROJECT:
ADB-202R-2019:PROCUREMENT OF PLANT, DESIGN, SUPPLY, INSTALLATION, TESTING, AND COMMISSIONING OF SCADA PHASE-3 AND REVENUE METERING SYSTEM (RMS) NTDCL LOAN NO.3577-PAK; SECOND POWER TRANSMISSION INVESTMENT PROGRAM, TRANCHE-2

DRAWING TITLE:
MICROWAVE STATION
120M GUYED MAST TOWER
PROPOSED CABLE ROUTING SITE LAYOUT PLAN

SCALE: NTS
SITE ADDRESS:
220 KV GRID STATION ISLAMABAD PESHAWAR ROAD (SANGJANI)

SITE I.D.
ISPR 220KV

SCALE	DRAWN	DESIGNED	CHECKED	APPROVED	DATE
AS SHOWN	M.K	SAJID	KAMRANZ	F.A.KHARRI	17-10-24
	JOB NO.		DRAWING NO.		REV.
	--		LDP-BA-SR116-DWG-E002		03

Past Experience / Contracts

Contracts over *[insert amount]* during the last three years:

Procuring Agency	Value	Year	Goods/Services Supplied	Country of Destination



Historical Contract Non-Performance, and Pending Litigation and Litigation History

[The following table shall be filled in for the Applicant and for each member of a Joint Venture]

Applicant's Name: *[insert full name]*

Date: *[insert day, month, year]*

Joint Venture Member Name: *[insert full name]*

IFP No. and title: *[insert IFP number and title]*

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<input type="checkbox"/> Not debarred due to deviation from commitment of Bid Securing Declaration- <input type="checkbox"/> Not debarred due to non-performance			
Year	Non-performed portion of contract	Contract Identification	Total Contract Amount (current value, currency, exchange rate and PKR equivalent)
<i>[insert year]</i>	<i>[insert amount and percentage]</i>	Contract Identification: <i>[indicate complete contract name/ number, and any other identification]</i> Name of Procuring Agency: <i>[insert full name]</i> Address of Procuring Agency: <i>[insert street/city/country]</i> Reason(s) for nonperformance: <i>[indicate main reason(s)]</i>	<i>[insert amount]</i>
Pending Litigation, in accordance with Section III, Qualification Criteria and Requirements			
<input type="checkbox"/> Pending litigation in accordance with Section III, Qualification Criteria and Requirements, Sub-Factor 2.3 as indicated below.			
Year of dispute	Amount in dispute (currency)	Contract Identification	Total Contract Amount (currency), US\$ PKR Equivalent (exchange rate)

[insert year]	[insert amount]	<p>Contract Identification: [indicate complete contract name, number, and any other identification]</p> <p>Name of Procuring Agency: [insert full name]</p> <p>Address of Procuring Agency: [insert street/city/country]</p> <p>Matter in dispute: [indicate main issues in dispute]</p> <p>Party who initiated the dispute: [indicate "Procuring Agency" or "Supplier"]</p> <p>Status of dispute: [Indicate if it is being treated by the Adjudicator, under Arbitration or being dealt with by the Judiciary]</p>	[insert amount]
<input type="checkbox"/> No consistent history of court/arbitral award decisions in accordance with Section III, Qualification Criteria and Requirements, Sub-Factor 2.4. <input type="checkbox"/> Consistent history of court/arbitral award decisions in accordance with Section III, Qualification Criteria and Requirements, Sub-Factor 2.4 as indicated below.			
Year of award	Outcome as percentage of Net Worth	Contract Identification	Total Contract Amount (currency), PKR Equivalent (exchange rate)
[insert year]	[insert percentage]	<p>Contract Identification: [indicate complete contract name, number, and any other identification]</p> <p>Name of Procuring Agency: [insert full name]</p> <p>Address of Procuring Agency: [insert street/city/country]</p> <p>Matter in dispute: [indicate main issues in dispute]</p> <p>Party who initiated the dispute: [indicate "Procuring Agency" or "Supplier"]</p> <p>Court/ arbitral award decision: [Indicate if the award decision was against the Applicant or any member of a joint venture.]y]</p>	[insert amount]

Current Contract Commitments / Contracts in Progress Form

1. Name of Contract(s)
2. Procuring Agency Contact Information [insert address, telephone, fax, e-mail address]
3. Value of outstanding contracts [current PKR equivalent]
4. Estimated Delivery Date
5. Average monthly invoices over the last six months (PKR/mon.)

Financial Situation and Performance

[The following table shall be filled in for the Applicant and for each member of a Joint Venture]

Applicant's Name: *[insert full name]*

Date: *[insert day, month, year]*

Joint Venture Member Name: *[insert full name]*

IFP No. and title: *[insert IFP number and title]*

Page *[insert page number]* of *[insert total number]* pages

1. Financial data

Type of Financial information in (currency)	Historic information for previous <i>[insert number]</i> years, <i>[insert in words]</i> (amount in currency, currency, exchange rate*, PKR equivalent)				
	Year 1	Year 2	Year 3		
Statement of Financial Position (Information from Balance Sheet)					
Total Assets (TA)					
Total Liabilities (TL)					
Total Equity/Net Worth (NW)					
Current Assets (CA)					
Current Liabilities (CL)					
Working Capital (WC)					
Information from Income Statement					
Total Revenue (TR)					
Profits Before Taxes (PBT)					
Cash Flow Information					
Cash Flow from Operating Activities					

* Refer ITA 14 for the exchange rate

3. Financial documents

The Applicant and in case of JV, members of JV shall provide copies of financial statements for *[number]* years pursuant Section III, Qualifications Criteria and Requirements. The financial statements shall:

- (a) reflect the financial situation of the Applicant or in case of JV member, and not an affiliated entity (such as parent company or group member).
 - (b) be independently audited or certified in accordance with local legislation.
 - (c) be complete, including all notes to the financial statements.
 - (d) correspond to accounting periods already completed and audited.
- Attached are copies of financial statements¹ for the *[number]* years required above; and complying with the requirements.

¹ If the most recent set of financial statements is for a period earlier than 12 months from the date of Application, the reason for this should be justified.

Average Annual Turnover (Annual Sales Value)

[The following table shall be filled in for the Applicant and for each member of a Joint Venture]

Applicant's Name: *[insert full name]*

Date: *[insert day, month, year]*

Joint Venture Member Name: *[insert full name]*

IFP No. and title: *[insert IFP number and title]*

Page *[insert page number]* of *[insert total number]* pages

Annual Turnover Data			
Year	Amount Currency	Exchange rate* (If applicable)	PKR equivalent
<i>[indicate calendar year]</i>	<i>[insert amount and indicate currency]</i>		
		Average Annual Turnover **	

* Refer ITA for date and source of exchange rate.

** Total PKR equivalent for all years divided by the total number of years. See Section III, Qualification Criteria and Requirements, ITA.